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BOROUGH OF METUCHEN

MIDDLESEX COUNTY

Tel. (732) 632-8540 • Fax (732) 632-8100 • 500 Main Street • Metuchen, N.J. 08840

APPLICATION FOR DEVELOPMENT

Control Information (C	Office Use Only)
Application Number	Applicant Name Date Received Date Deemed Complete
1. Application	
A. Location	
Street Address	326 Durham Ave Metuchen NJ - 0881
Block	40 Lot 37 Zone R-2
Situated on	Vorth side of Durham Are
distant	O feet from westing house Spreet
B. The Site is Located	
U Within 200' of Edisc	on Township Adjacent to County Road Adjacent to State Highway
C. Status:	
New D	Revision or Resubmission of Prior Application No.
D. Type (Check all that App	
Concept	Preliminary Final Conditional Use Approval
Minor Site Plan	Major Site Plan Minor Subdivision Major Subdivision
🗆 (a) – Appeal	□ (b) – Interpretation □ (c) – Variance (Bulk) □ (d) – Variance (Use)
Request for Waiver	of Submission Requirements Other
E. Nature of Relief or V	ariance Request (List Ordinance Reference Sections)
Adding	a new second floor on an existin
non-confi	rmine house
F. Date and Disposition	n of any previous Board Hearings involving this Site
	Nore known
G. Plat Submission (List	t maps and other exhibits accompanying this application)
Proposed	construction plans by Architect
John R	ggio Landscape plan by Fletcher Er
	00
	1

2. Applicant Information

A. Applicant	RAND HOME TNUETTMENTS	Phone 732 233 4744
First Name	The Treedword	Phone 732 233 4744
Last Name		Phone
	5266 Foster St	
City / State	iscataway NJ zip 0885	Email AAMIRALIE HOTMAIL ON
B. Applicant is a/an		
🗆 Individual	Partnership Corporation	Other
C. Applicant's Rela	tionship to Owner:	
12 Owner	Lessee Purchaser Under Con	tract Other
D. Owner (If other than	Applicant: requires Owner's Consent on Page 6)	
First Name		Phone
Last Name		Phone
Street Address		Fax
City / State	Zip	Email
3. Applicant's Ex	(perts	
A. Attorney (Required	If Applicant is a Corporation; must be a licensed in the Sta	ate of New Jersey)
Name	John wiley	Phone 732-494- 6099
Street Address		
City / State M	etuchen NJ Zip 08840	Email John e wiley Lavender . wom
o. Lindineer		v
Name	Paul J Fletcher	Phone 732 738 8807
Street Address	PY W Pend Rd	Fax
City / State	ope Lawn, NJ Zip 08861	Email Paul j fletcher e comcast. net
C. Architect		
Name	John Riggio	Phone 732 402 2812
Street Address	116 Main ST	Fax
City / State	Metuchen NJ Zip 08840	Email John-r. @ Usa net
D. Other Profession	al Consultants	
Name		Phone
Street Address		Fax
City / State	Zip	Email

4. Plat / Plan Data

A. Present Use of Land / Structure

		Single family fesilence	
			<u>.</u>
B. Proposed	Use of Land / S		
		Single Family Residence	
		0	
C. Building D	ata	. 4	
Existing :	Floor Area:	1372.49 st Height in Stories & Feet: 1 Story 15	/
Addition:	Floor Area:	16 00 05 59 44 Height in Stories & Feet:	
New Bldg:	Floor Area:	20100 Tabay de Height in Stories & Feet:	
Total Floor Ar	rea:	2970:71 St St w Garage 2 Story	30
D. Subdivisio	n Data	i stoff startage start	Ĭ
Area:	Entire Tract:	Portion being subdivided:	
No. of Lots:	Present	Proposed:	
No. of Units:	Demolished:	Proposed:	
Purpose:			
E. Non-Reside	ential Use Data		
Total Floor An	ea of Building:	Present Proposed	
Floor Area to I	5.2		
Off-Street Parl			
Number of Em	ployees:		
Days & Hours	of Operation:		
Machinery / Ed	quipment Used:	The strength watched a man that make the state of the strength	
Description of	Operation(s):		
		1. Solution of the second s	
		3	

5. Request for Bulk Variance

A. Bulk Regulations

	District Requirements	Present	Proposed	Variance
Min. Lot Area	7500	6250	6250	
Min. Lot Width	62-51	50'	<u> </u>	10
Min. Lot Depth (Average)	100'	1201	1201	
Min. Front Yard Setback	251	36.4'	92:04'	п
Min. Side Yard Setback (Left)	17.2'	17.21	$-\frac{\alpha}{12} \frac{1}{2} \frac{1}{2}$	
Min. Side Yard Setback (Right)	81	3.51	-1.12	ET I
Min. Side Yard Setback (Combined) N	I/A			
Min. Rear Yard Setback	25'	33.27	33.27	
Max. Building Coverage	30%	22 %	24.1	
Max. Impervious Coverage	40%	37%	29.5%	
Max. Height	351	151	30'	
B. Describe below the nature of the c	onstraints imposed by	the physical sharest		

B. Describe below the nature of the constraints imposed by the physical characteristics of the property.

5

C. Describe below any other exceptional conditions of the property that prevent the applicant from complying with the Zoning Ordinance.

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D. Describe below how not granting this variance request would impose difficulties or undue hardship upon you.

obse 0 in m 13 home nov

desig .

E. Describe below how the granting of the variance request will not result in substantial detriment to the public good nor substantially impair the intent and purpose of the Zone Plan and the Zoning Ordinance.

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6. Request for Conditional Use Approval / Use Variance

A. Describe below the specifics of the request.

B. Describe below the special reasons which exist that support the granting of the request.

C. Describe below how the public interest will be served by the granting of the request.

D. Describe below what circumstances exist or what measures will be taken to ensure that, if the request is

granted, the surrounding property owners will experience no adverse impact or undue burden.

E. Describe below how the granting of the request will not result in substantial detriment to the public good nor substantially impair the intent and purpose of the Zone Plan and the Zoning Ordinance.

7. Correspondence

A Damas 4

A. Person to be contacted in regard to all matters pertaining to this Application (If other than Applicant
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First Name		Phone	
Last Name		Phone	
Street Address		Fax	
City / State	Zip	Email	

8. Verification and Authorization

I, THE UNDERSIGNED, HEREBY MAKE APPLICATION FOR AN APPLICATION FOR DEVELOPMENT ONLY FOR THE LOCATION AND THE WORK DESCRIBED HEREIN AND CERTIFY TO THE ACCURACY OF THAT INFORMATION. I ACKNOWLEDGE THAT IT IS MY RESPONSIBILITY TO BE AWARE OF AND COMPLY WITH ALL ZONING REQUIREMENTS OF THE BOROUGH OF METUCHEN RELATING TO THIS APPLICATION. I UNDERSTAND THAT FAILURE TO PROVIDE ACCURATE INFORMATION OR TO COMPLY WITH ANY PROVISIONS OF THE APPLICATION RENDERS IT NULL AND VOID AND MAY RESULT IN AN ENFORCEMENT ACTION.

CONSTRUCTION OF IMPROVEMENTS WILL NOT BE COMMENCED AT THE ABOVE LOCATION UNTIL THE APPLICANT/OWNER IS IN COMPLIANCE WITH ALL APPLICABLE REGULATIONS REGARDING ZONING AND PROPERTY MAINTENANCE AS DEFINED BY THE CODE OF THE BOROUGH OF METUCHEN. THIS APPLICATION AND ASSOCIATED APPROVALS DO NOT WAIVE ANY OTHER RESTRICTIONS OR REGULATIONS IMPOSED PRIVATELY OR BY LAW.

A. Applicant's Verification

I HEREBY CERTIFY THE STATEMENTS CONTAINED IN THIS APPLICATION ARE TRUE.

Name	AAMIR MOTIVALA	Date	4/27/22
Signature	A		, <u>,</u>

B. Owner's Authorization

I HEREBY CERTIFY THAT I AM THE OWNER OF RECORD OF THE PROPERTY DESCRIBED HEREON AND THAT I CONCUR WITH THE DOCUMENTS PRESENTED TO THE PLANNING BOARD / ZONING BOARD OF ADJUSTMENT. I HEREBY AUTHORIZE THE APPLICANT TO SUBMIT THIS APPLICATION FOR DEVELOPMENT.

Name	AAMIR MOTINALA Date	4/27/22
Signature	-	
Telephone	& Fax Number: 732 233 4744	

ADDITION AND ALTERATION TO ONE FAMILY HOUSE 326 DURHAM AVENUE, METUCHEN, NJ 08840

GENERAL NOTES CONSTRUCTION NOTES:

CONCRETE AND MASONRY

1. THE BEARING STRENGTH OF THE POURED CONCRETE FOR

FOUNDATIONS MUST BE A MINIMUM OF 4,000 PSI. THE BEARING STRENGTH FOR SIDEWALKS AND CONCRETE SLABS MUST BE A MINIMUM OF 3,200 PSI. CSI DIV. 03 CONCRETE.

2. CONCRETE DESIGN MEETS AMERICAN CONCRETE INSTITUTE (ACI) CODE.

3. CONCRETE SHALL CONSIST OF CEMENT, WATER, AND AGGREGATE.

4. MASONRY IS TO MEET ANSI A41.1 REQUIREMENTS.

5. BRICK MUST MEET ASTM C62 USE GRADE SW (SEVERE WEATHERING) AND USE. STANDARD MODULAR SIZE BRICK UNLESS OTHERWISE SPECIFIED. "N" NORMAL GROUT IS TO USED.

6. BLOCK IS TO BE GRADE "N" NORMAL AND MORTAR IS TO BE "N" NORMAL MEETING ASTM C90 LOADBEARING BLOCK.

7. UNREINFORCED LENGTH AND HEIGHTS SHOULD NOT EXCEED ANSI A41.1 STANDARDS.

8. THE CONCRETE CONTRACTOR MUST VERIFY PROPER CONCRETE PSI AT TIME OF POUR.

METAL AND STEEL:

1. THE STEEL USED SHOULD BE ASTM 36 ALL-PURPOSE CARBON GRADE STEEL. CSI DIV 05 METALS.

2. STEEL SHAPES AND CONNECTIONS ARE TO MEET AISC STANDARDS. PROVIDE WELDED WEB STIFFENERS FOR ALL STEEL SHAPES.

3. METAL STUD WALLS SPACED AT 12" O.C. AND 16" O.C. ARE TO HAVE HORIZONTAL REINFORCING EVERY 4'-0" O.C. VERTICALLY AND BRACING AT THE CORNERS.

4. METAL STUD WALLS ARE NOT TO EXCEED THE MAXIMUM HEIGHT ALLOWED ACCORDING TO THE MANUFACTURER'S SPECS


5. WELDING IS TO MEET AWS D1.1-80 AND THE AISC SPECIFICATIONS. PROVIDE CONTINUOUS ALL AROUND WELDING AT CONNECTIONS

WOOD:

1. STRUCTURAL WOOD MEMBERS ARE TO BE DOUGLAS-FIR MIN 1,250 PSI STRUCTURAL GRADE LUMBER. KILN DRIED AND GRADE STAMPED. CSI DIVISION 06 WOOD, PLASTICS, AND COMPOSITES.

ABBREVIATIONS

ABV	ABOVE	INSTL	INSTALL
ADD	ADDITION	JB	JUNCTION BOX
ADH	ADHESIVE	LAM	LAMINATE
BD	BOARD	LL	LIVE LOAD
BLDG	BUILDING	МО	MASONRY OPENING
CLG	CEILING	MET	METAL
CL	CENTER LINE	NTS	NOT TO SCALE
CONST	CONSTRUCTION	OC	ON CENTER
DEG	DEGREE	OD	OUTSIDE DIAMETER
DR	DOOR	PL	PLATE
EQUIP	EQUIPMENT	PT	PAINT
EXP JT	EXPANSION JOINT	R	RADIUS
FIN	FINISH	SS	STAINLESS STEEL
FD	FLOOR DRAIN	STD	STANDARD
FTG	FOOTING	TEL	TELEPHONE
GA	GAGE	UND	UNDER
GYP	GYPSUM	V	VOLTAGE
HT	HEIGHT	W	WALL
HM	HOLLOW METAL	WD	WOOD

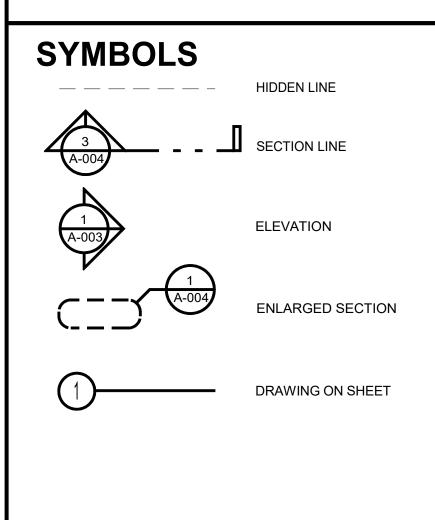

2. WOOD STUD WALLS SPACED 12" O.C. AND 16" O.C. ARE TO HAVE HORIZONTAL BRACING 4'-0" VERTICALLY.

3. ROOF RAFTERS SPACED 12" O.C. & 16" O.C. ARE TO HAVE BRACING AT A 45 DEG ANGLE SPACED EVERY 6'-0" O.C.

4. CEILING AND ROOF JOISTS SPACED 12" O.C. AND 16" O.C. ARE TO HAVE DIAGONAL BRACING EVERY 4'-0" O.C.

5. WOOD FLOOR & WALLS MUST HAVE FIREBLOCKING AT EACH FLOOR LEVEL AND BETWEEN DIFFERENT SPACE USES.

6. WINDOW AND DOOR HEADERS FOR BEARING WALLS ARE (2) 2 X 6'S AND FOR NON-BEARING WALLS ARE (2) 2X4'S.

7. PLYWOOD SHEATHING IS TO BE HEM-FIR CDX FOR EXTERIOR WALLS AND HEM-FIR APA FOR ROOF SHEATHING. 3/4" HEM-FIR IS TO BE USED FOR FLOORING.

8. ROOFS ARE TO HAVE STRAPS FOR HURRICANE FORCE WINDS.

9. WOOD BASE PLATES SHOULD HAVE CONTINUOUS TERMITE STRIPS ALONG THE FOUNDATION.

FINISHES:

1. GYPSUM PRODUCT INSTALLATION MUST CONFORM TO THE ASTM AND GYPSUM ASSOCIATION. CSI DIVISION 09 FINISHES

2. USE TYPE "X" FIRE-RATED ASTM 36 AND GA 216, 600 INSTALLATION STANDARDS. TAPE AND SPACKLE ALL GYPSUM BOARD INSTALLATION FOR FIRERATED WALLS.

3. FOR EXTERIOR APPLICATIONS USE EXTERIOR GYPSUM SHEATHING ASTM STANDARD C1177 AND GA 253 INSTALLATION STANDARDS.

PLUMBING

LOCATION.

1. INSTALLATION IS TO MEET DEP STANDARDS, THE NATIONAL PLUMBING CODE, AND ANSI A40.8. CSI DIVISION 22 PLUMBING.

2. DRIP VALVES AND SHUT-OFF VALVES MUST BE INSTALLED AT LOW POINT IN WATER SUPPLY SYSTEM.

3. INSTALL SHOCK ABSORBERS TO PREVENT WATER HAMMER

4. WASTE MAINS ARE TO BE CAST IRON OR EHCI PIPING IN NYC, THEY MAY BE P.V.C. ELSEWHERE.

5. A WASTE CLEAN-OUT MUST BE INSTALLED AT EXTERIOR WALL

SITE CALCULATIONS

326 DURHAM AVENUE, METUCHEN, NJ 08840 BLOCK 40 LOT 37 USE GROUP = R-5 - ONE FAMILY RESIDENTIAL CONST CLASS = TYPE 5B WOOD FRAME ZONING DISTRICT = R-2 RESIDENTIAL DISTRICT BOROUGH OF METUCHEN ZONING CODE 110-64 BULK REQUIREMENTS MINIMUM LOT AREA = 7,500 SF 50' X 125' = 6,250 SF EXISTING NON- COMPLYING 110-64 MIN LOT WIDTH MINIMUM LOT WIDTH REQ. = 62.5' > 50.00' EXISTING NON-COMPLYING 110-64 MIN LOT DEPTH MINIMUM LOT DEPTH REQ. = 100' < 125' EXISTING 110-64 REQUIRED YARDS SOUTH FRONT YARD 25' REQ. < 27.08' PROPOSED WEST FRONT YARD 17.2' REQ. >= 17.2' EXISTING NOTE 1 EAST SIDE YARD 8' MIN REQ. > 3.5' EXISTING NON-COMPLYING REAR YARD 25' MIN REQ. < 33.27' PROPOSED 110-68 PERMITTED USES A. SINGLE FAMILY DETACHED DWELLINGS 110-64 MAXIMUM BUILDING HEIGHT MAXIMUM 3 STORIES AND 35' HIGH > 2 STORIES, 30' HIGH PROPOSED HOUSE FLOOR AREA (CELLAR FLOOR AREA = 38' X 25' 10 1/2" = 958.49 SF EXISTING) (FIRST FLOOR GARAGE AREA = 18' X 25' 10 1/2" = 465.75 SF) FIRST FLOOR AREA = 38' X 25' 10 1/2" = 1,372.49 SF EXISTING FIRST FLOOR ADDITION = 8' X 15' 6" = 113.78 SF PROPOSED TOTAL FIRST FLOOR AREA = 1,486.27 SF SECOND FLOOR AREA 53'11 1/2" X 25' 10 1/2" = 1396.17 SF + 10' 1/2" X 15' 6" = 155.65 SF = 1,551.82 SF TOTAL 2ND FLOOR AREA = 1,484.44SF TOTAL FLOOR AREA OF ADDITIONS 1,600.05 SF PROPOSED TOTAL HOUSE FLOOR AREA /WO GARAGE = 2,627.87 SF PROPOSED TOTAL HOUSE FLOOR AREA = 2,970.71 SF PROPOSED 110-64 MAX LOT COVERAGE W/ ACCES. 6,250 SF X .30 = 1,875.00 SF > 1,486.27 SF PROPOSED (24%) 110-64 MAX LOT COVERAGE BLDGS AND PAVEMENT 6,250 SF X .40 = 2,500.00 SF > 2,473.27 SF PROPOSED (39.5%) VOLUME OF ADDITIONS 1,838.24 SF X 9' = 16,544.16 SF PROPOSED OFFSTREET PARKING TOTAL 3 CAR PARKING PROPOSED EXG 1 CAR GARAGE AREA = 18' X 25' 10 1/2" = 465.75 SF EXG 1 CAR GARAGE AREA = 16' X 21' 6 1/2" = 344.67 SF

6. FRESH AIR INTAKE MUST BE INSTALLED 6" ABOVE GRADE.

7. AIR VENT STACK MUST PENETRATE ROOF SURFACE.

8. P.V.C. PIPING MAY BE USED UP TO A THREE FAMILY HOUSE, GREATER THAN THREE FAMILIES OR ANY COMMERCIAL BUILDING WILL REQUIRE **ESVP PIPING THROUGHOUT**

HVAC

1. INSTALLATION OF HVAC UNITS AND DUCT WORK IS TO CONFORM WITH THE ASHRAE, CSI DIVISION 23 HVAC.

2. PIPING FOR HOT WATER AND STEAM HEAT SYSTEMS MUST BE PROPERLY FASTENED TO STRUCTURAL MEMBERS ACCORDING TO CODE.

3. DUCT WORK PENETRATIONS THROUGH FIREWALLS AND FLOORS MUST BE PROVIDED WITH FIREDAMPERS.

4. DUCT WORK MUST BE PROPERLY INSULATED AS PER CODE.

5. CHIMNEY FLUES WITHIN 10'-0" OF RIDGE LINE MUST EXTEND 3'-6" ABOVE THE HIGHEST POINT OF THE ROOF

ELECTRICAL

1. WIRING METHODS AND MATERIALS MUST COMPLY WITH NATIONAL ELECTRICAL CODE AND STATE CODE. CSI DIVISION 26 ELECTRICAL.

2. MATERIALS MUST MEET UL, NRTL, NEMA, OR NFPA TESTING LABORATORIES SPECIFICATIONS.

3. WIRING MUST BE GROUNDED FOR THE STRUCTURE WITH AN ELECTROPOLE.

4. CIRCUIT LOADS AND WIRING MUST BE VERIFIED BY A LICENSED **ELECTRICIAN**

5. ELECTRICAL CONTRACTOR MUST PROVIDE ALL ELECTRICAL HARDWARE FOR INSTALLATION.

6. ALL DUPLEX RECEPTACLES ARE TO BE INSTALLED 12" AFF AND FOR H.C. AND ADA LOCATION. THEY MUST BE 18" TO 4'-0" AFF.

7. WIRING MUST HAVE A MAIN SWITCH BOARD AT ELECTRICAL POWER FNTRY

8. ALL OUTLETS NEAR WATER OUTLETS AND SINKS MUST BE GFI - GROUND FORCE INTERRUPTER.

9. CIRCUITS IN A ROOM MUST HAVE ONE CIRCUIT BREAKER OUTLET.

ENERGY CALCULATIONS

CONFORMS TO NEW JERSEY STATE ENERGY CODE 2018 IECC LOCATION: METUCHEN, NJ CONSTRUCTION TYPE: SINGLE -FAMILY PROJECT TYPE: ADDITION HEATING DEGREE DAYS: 5227 HDD CLIMATE ZONE: 4 AIR HEATING, 78 AFUE ADDITION AND ALTERATION CAVITY CONT. WIN/DR AREA R-VALUE R-VALUE U-FACTOR SHGC UA FI EMENTS 3420 15 W/ALL 053 5

WALL	3420	15	5	.053	-	178
CEILING	1520	35		.030	-	40
WINDOW	379	-		.34	.18	121
FLOOR	3420	15	5	.031	-	6
DOORS	76	-		.34	.18	24
BASEWALL	68	-	20	.060	-	59
MAXIMUM UA	ALLOWE	ED 373 >	· 366 PROVIDE	ED COMPLI	ANCE PA	SSES

INFILTRATION RATES

DOORS .5 CFM/SF REQ. => .5 CFM/SF SPECIFIED WINDOWS .37 CFM/LF REQ. => .34 CFM/LF SPECIFIED

STRUCTURAL REQ.

CONFORMS TO NEW JERSEY CODE, TABLE 1607.1 REQUIRED LIVE LOADS CEL FLOOR = 40 PSF NJ CODE TABLE 1607.1 RESIDENTIAL 1ST, 2ND FLOOR = 40 PSF NJ CODE TABLE 1607.1 RESIDENTIAL CEILING = 10 PSF NJ CODE TABLE 1607.1 UNINHABITABLE W/O STOR. ROOF = 30 PSF NJ CODE 1607.11.2.1 EQUATION 16-4 DESIGN DEAD LOADS FLOORS = 12.1 PSF FIRST FLOOR CEILING = 4.0 PSF UNINHABITABLE

ROOF = 9.2 PSF SOILING BEARING PRESSURE = 2 TONS / SF 10. ENERGY EFFICIENT LIGHT BULBS MUST BE USED IN ALL NEW LIGHT FIXTURE INSTALLATIONS

BUILDING DEPARTMENT NOTES:

1. CONSTRUCTION IS IN COMPLIANCE WITH NEW JERSEY BUILDING CODES.

2. MATERIALS AND METHODS OF CONSTRUCTION ARE IN COMPLIANCE WITH THE APPLICABLE BUILDING CODE AND NECESSARY FORMS HAVE BEEN SUBMITTED TO THE LOCAL BUILDING DEPARTMENT. SPECIFICATIONS ARE LISTED IN CSI, MASTERFORMAT 2004.

3. THE BUILDING DEPARTMENT MUST BE NOTIFIED 24 HOURS PRIOR TO ALL EXCAVATION WORK INCLUDING DRYWELLS.

4. CONSTRUCTION WILL BE INSPECTED BY A LICENSED PROFESSIONAL AS LISTED BELOW UNDER INSPECTIONS. A CERTIFICATE OF COMPLETED INSPECTION AND REPORT MUST BE SUBMITTED TO THE BUILDING DEPARTMENT.

5. THE BUILDING PERMIT MUST BE POSTED IN A VISIBLE LOCATION TO THE FRONT EXTERIOR OF THE PROPERTY WITH THE OCCUPANCY AND USE STATED.

6. THE NEW OCCUPANTS MAY NOT USE THE STRUCTURE UNTIL A CERTIFICATE OF OCCUPANCY HAS BEEN OBTAINED.

PROJECT COMPLETION:

- 1. FOUNDATION, FRAMING, ETC. SPECIAL INSPECTIONS
- 2. FINAL INSPECTION
- 3. FINAL PLUMBING INSPECTION 4. FINAL ELECTRICAL INSPECTION
- 5. FINAL MECHANICAL INSPECTION, ETC.
- 6. BUILDING DEPARTMENT SIGN-OFF OR 7. CERTIFICATE OF OCCUPANCY

NEW JERSEY BUILDING CODE:

2018 IBC WITH ADMENTMENTS

NEC 2017 NSPC 2018 IMC 2018

PERMITS


CONSTRUCTION ELECTRICAL PLUMBING MECHANICAL


INSPECTIONS


- 1. EXCAVATION
- 2. FOUNDATION 3. FRAMING
- 4. FINAL

LIST OF DRAWINGS

T-001	TITLE SHEET AND PLOT PLAN
A-001	CELLAR AND FIRST FLOOR PLANS
A-002	SECOND FLOOR AND ROOF PLAN
A-003	HOUSE ELEVATIONS
A-004	RISER DIAGRAMS AND DETAILS
A-005	SECTIONS AND DETAILS

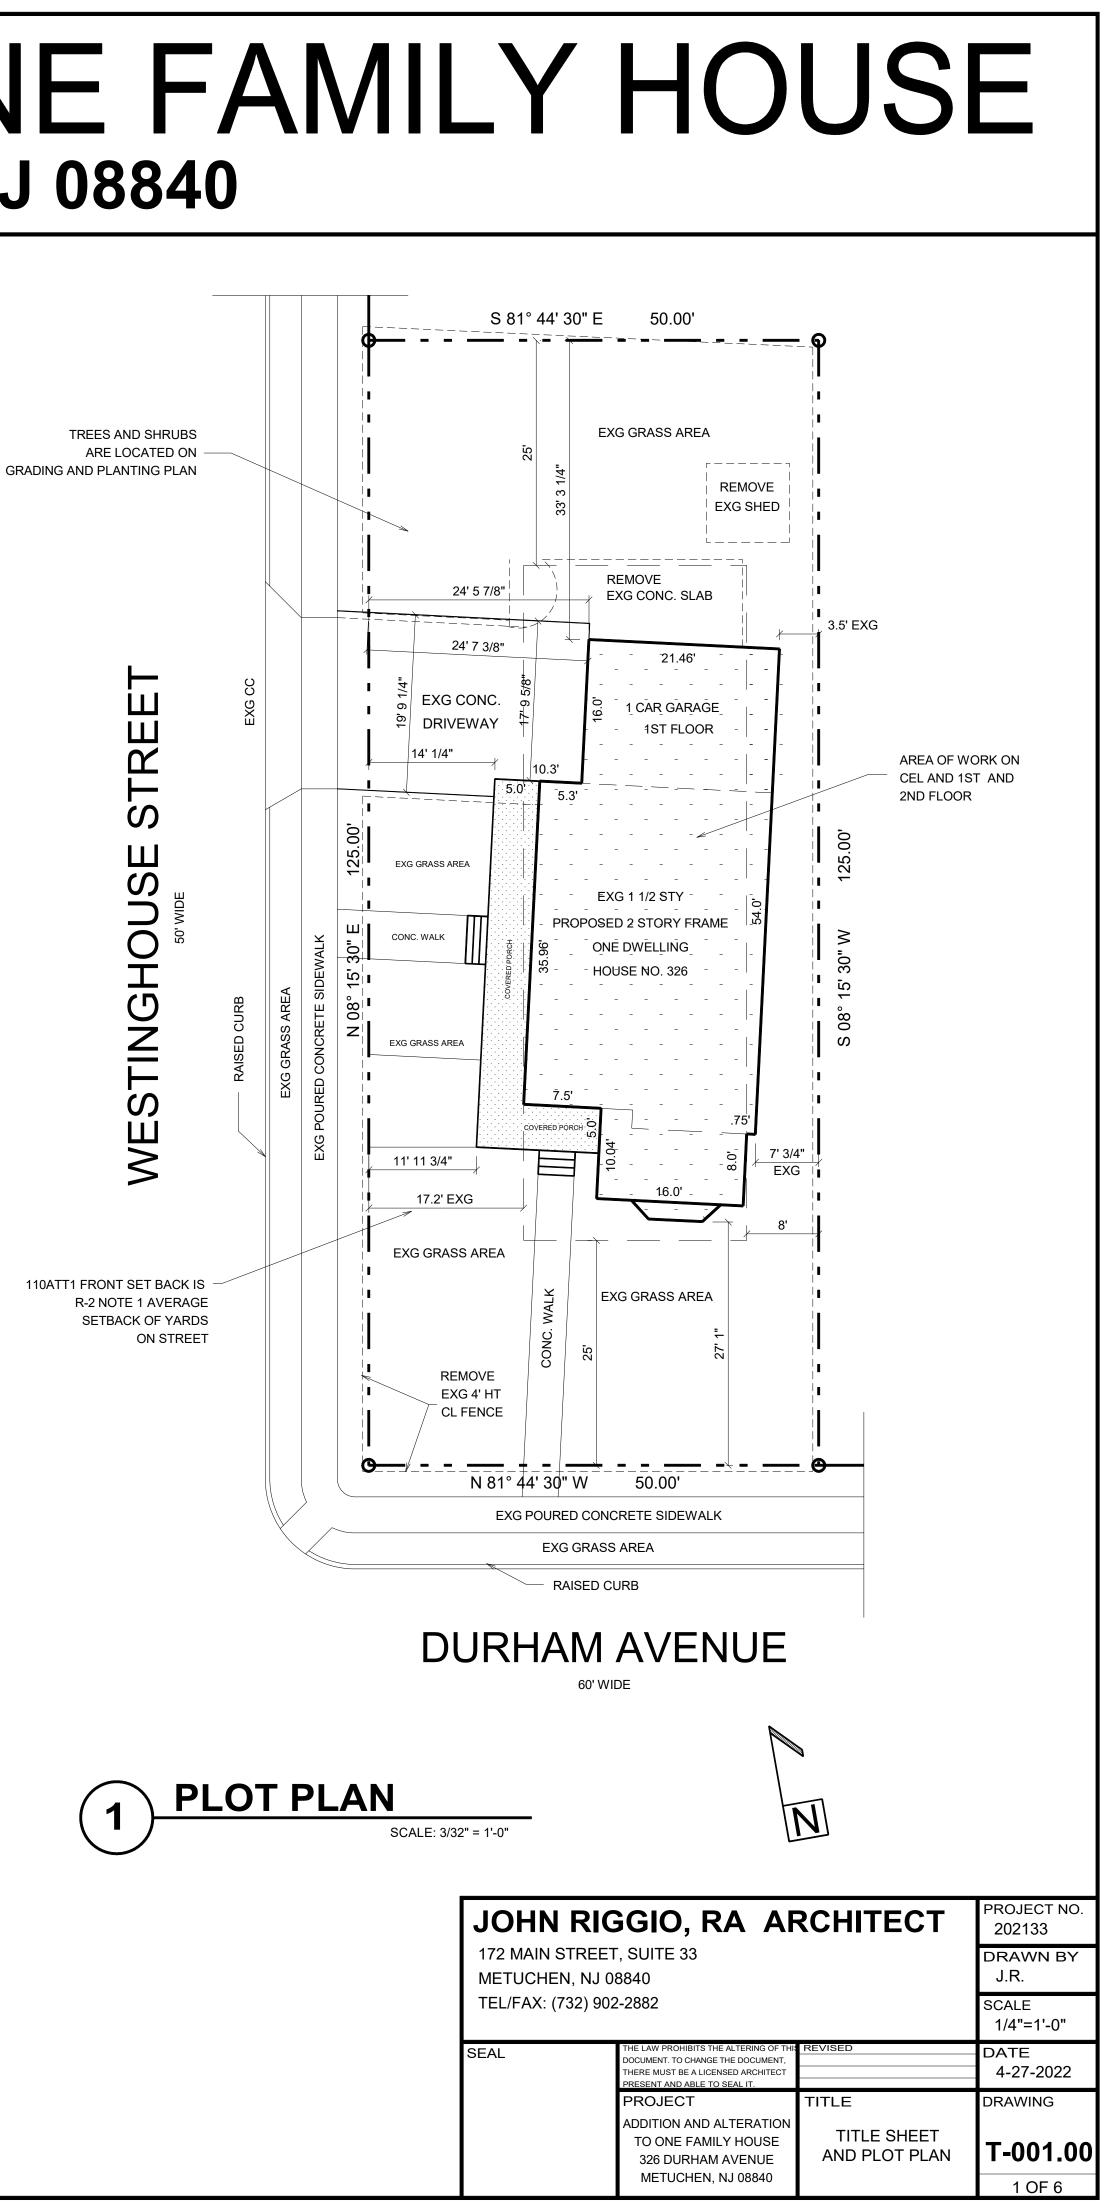

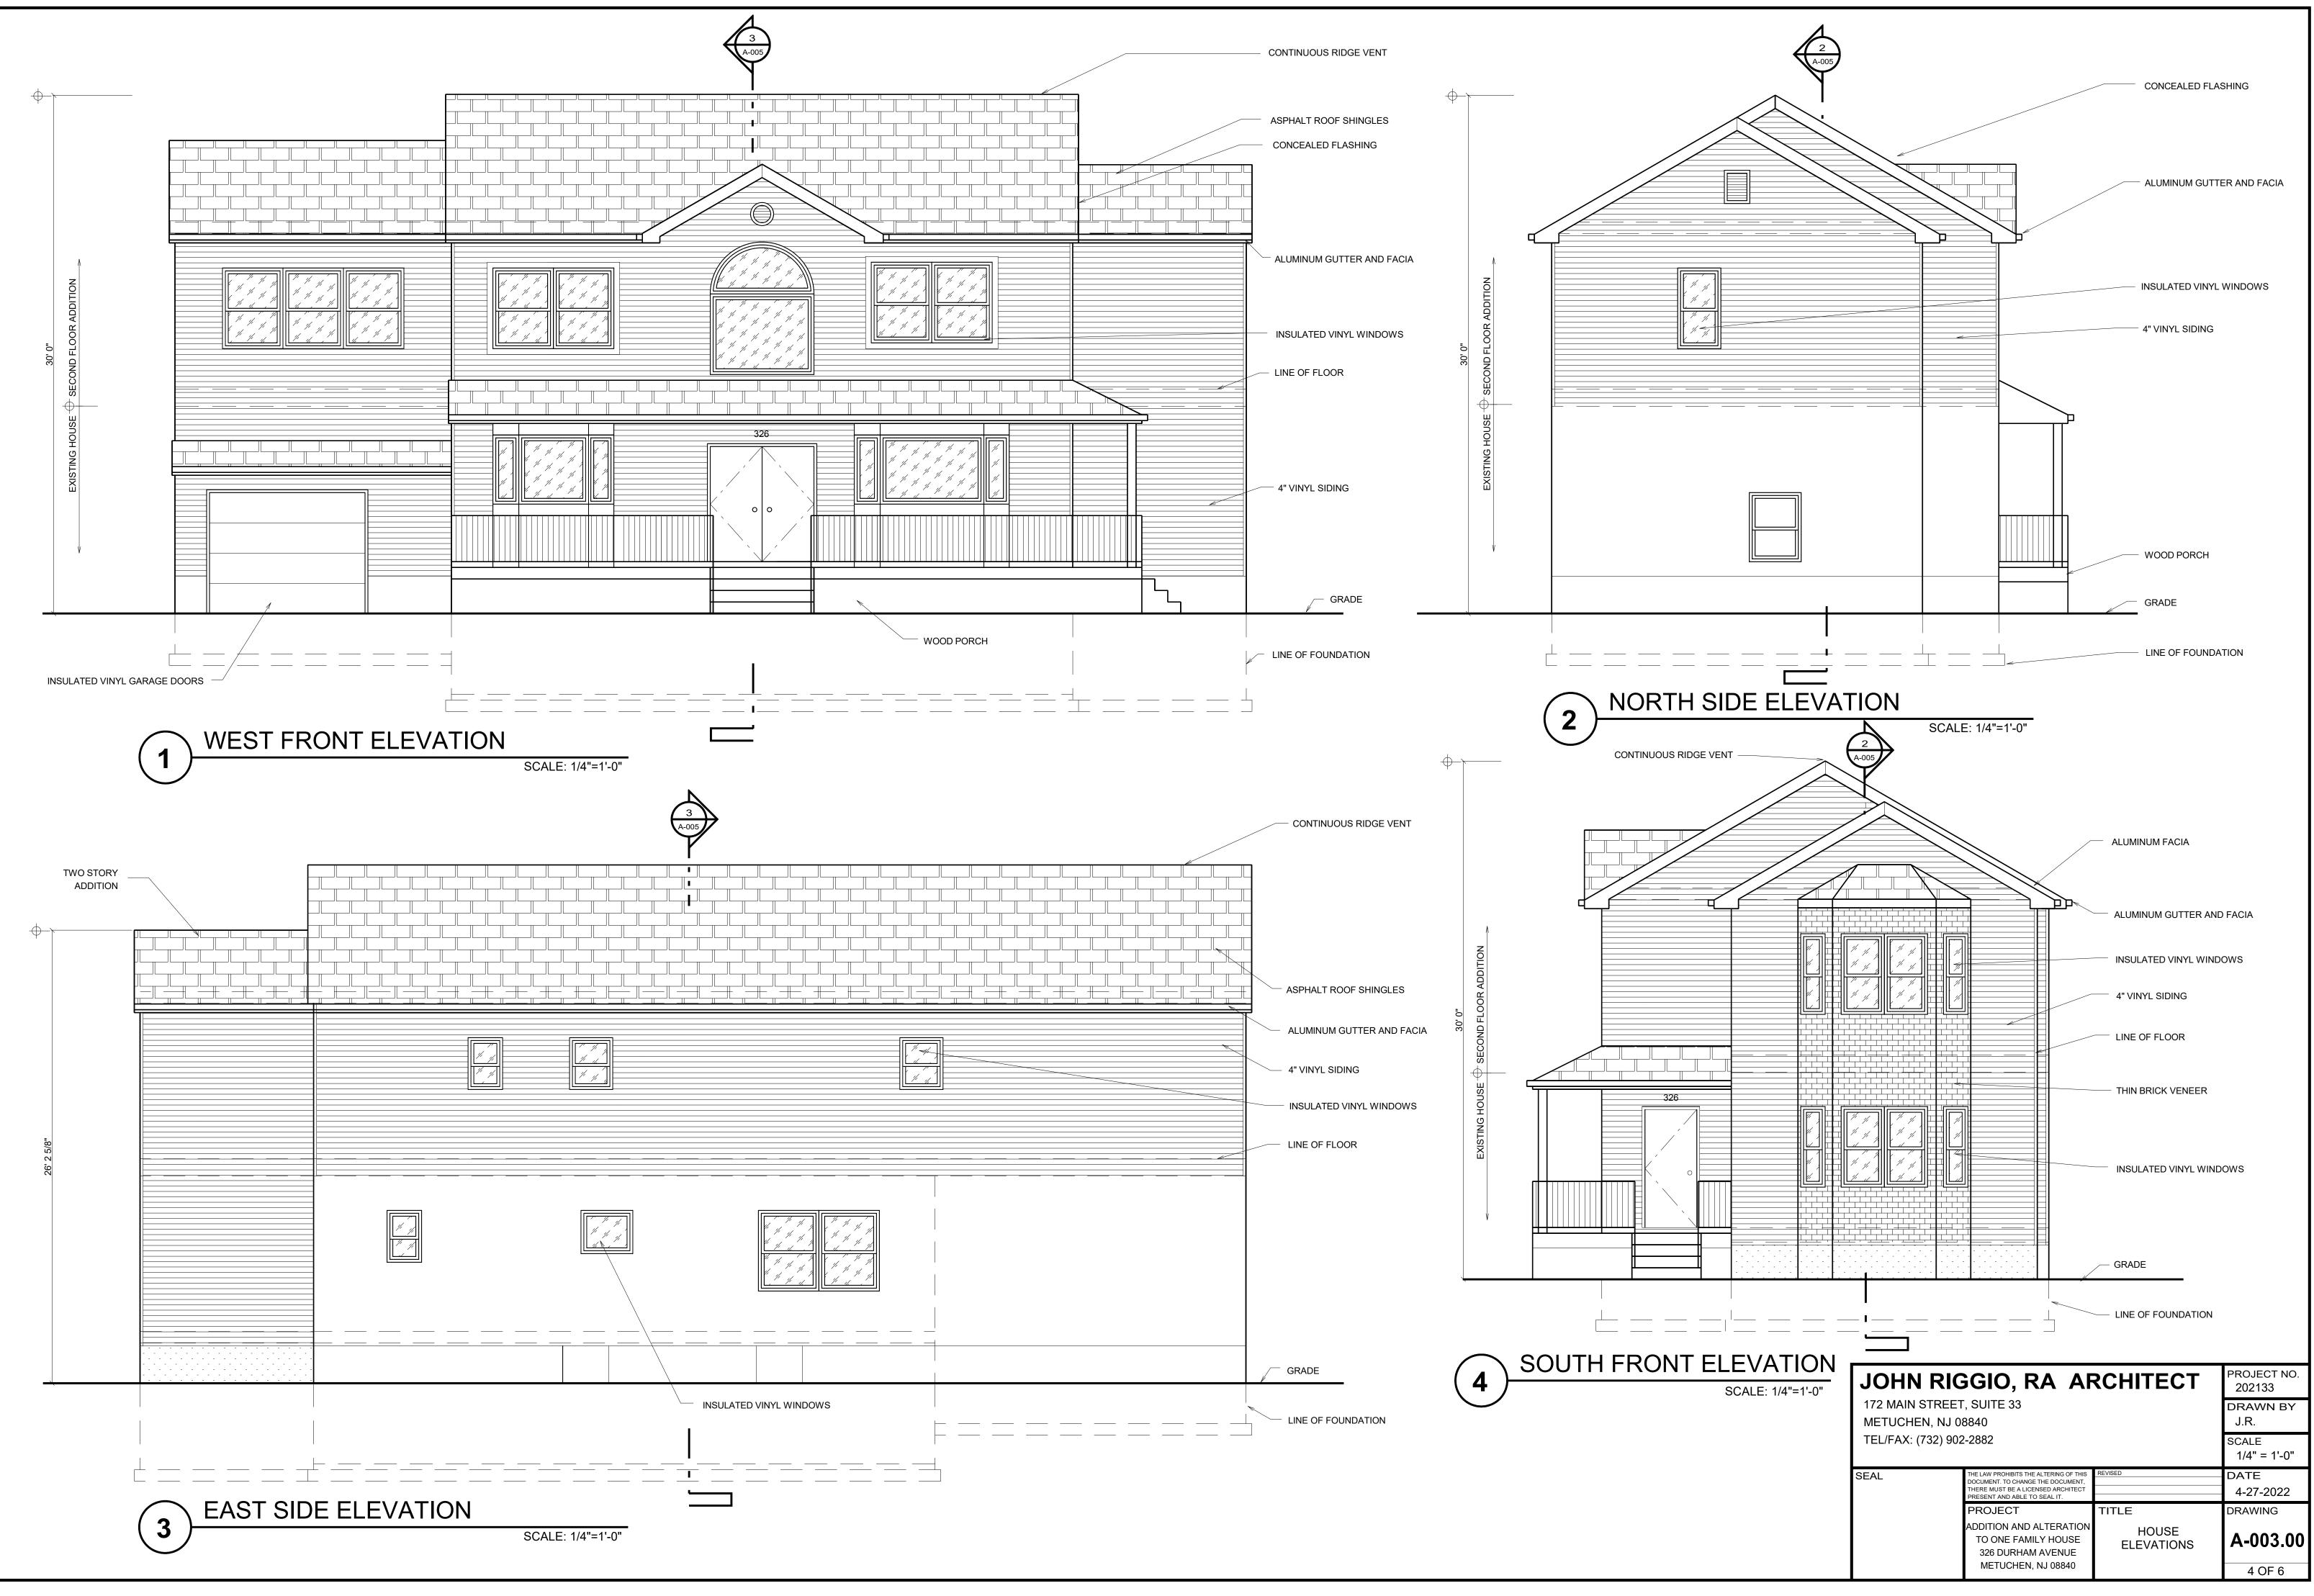


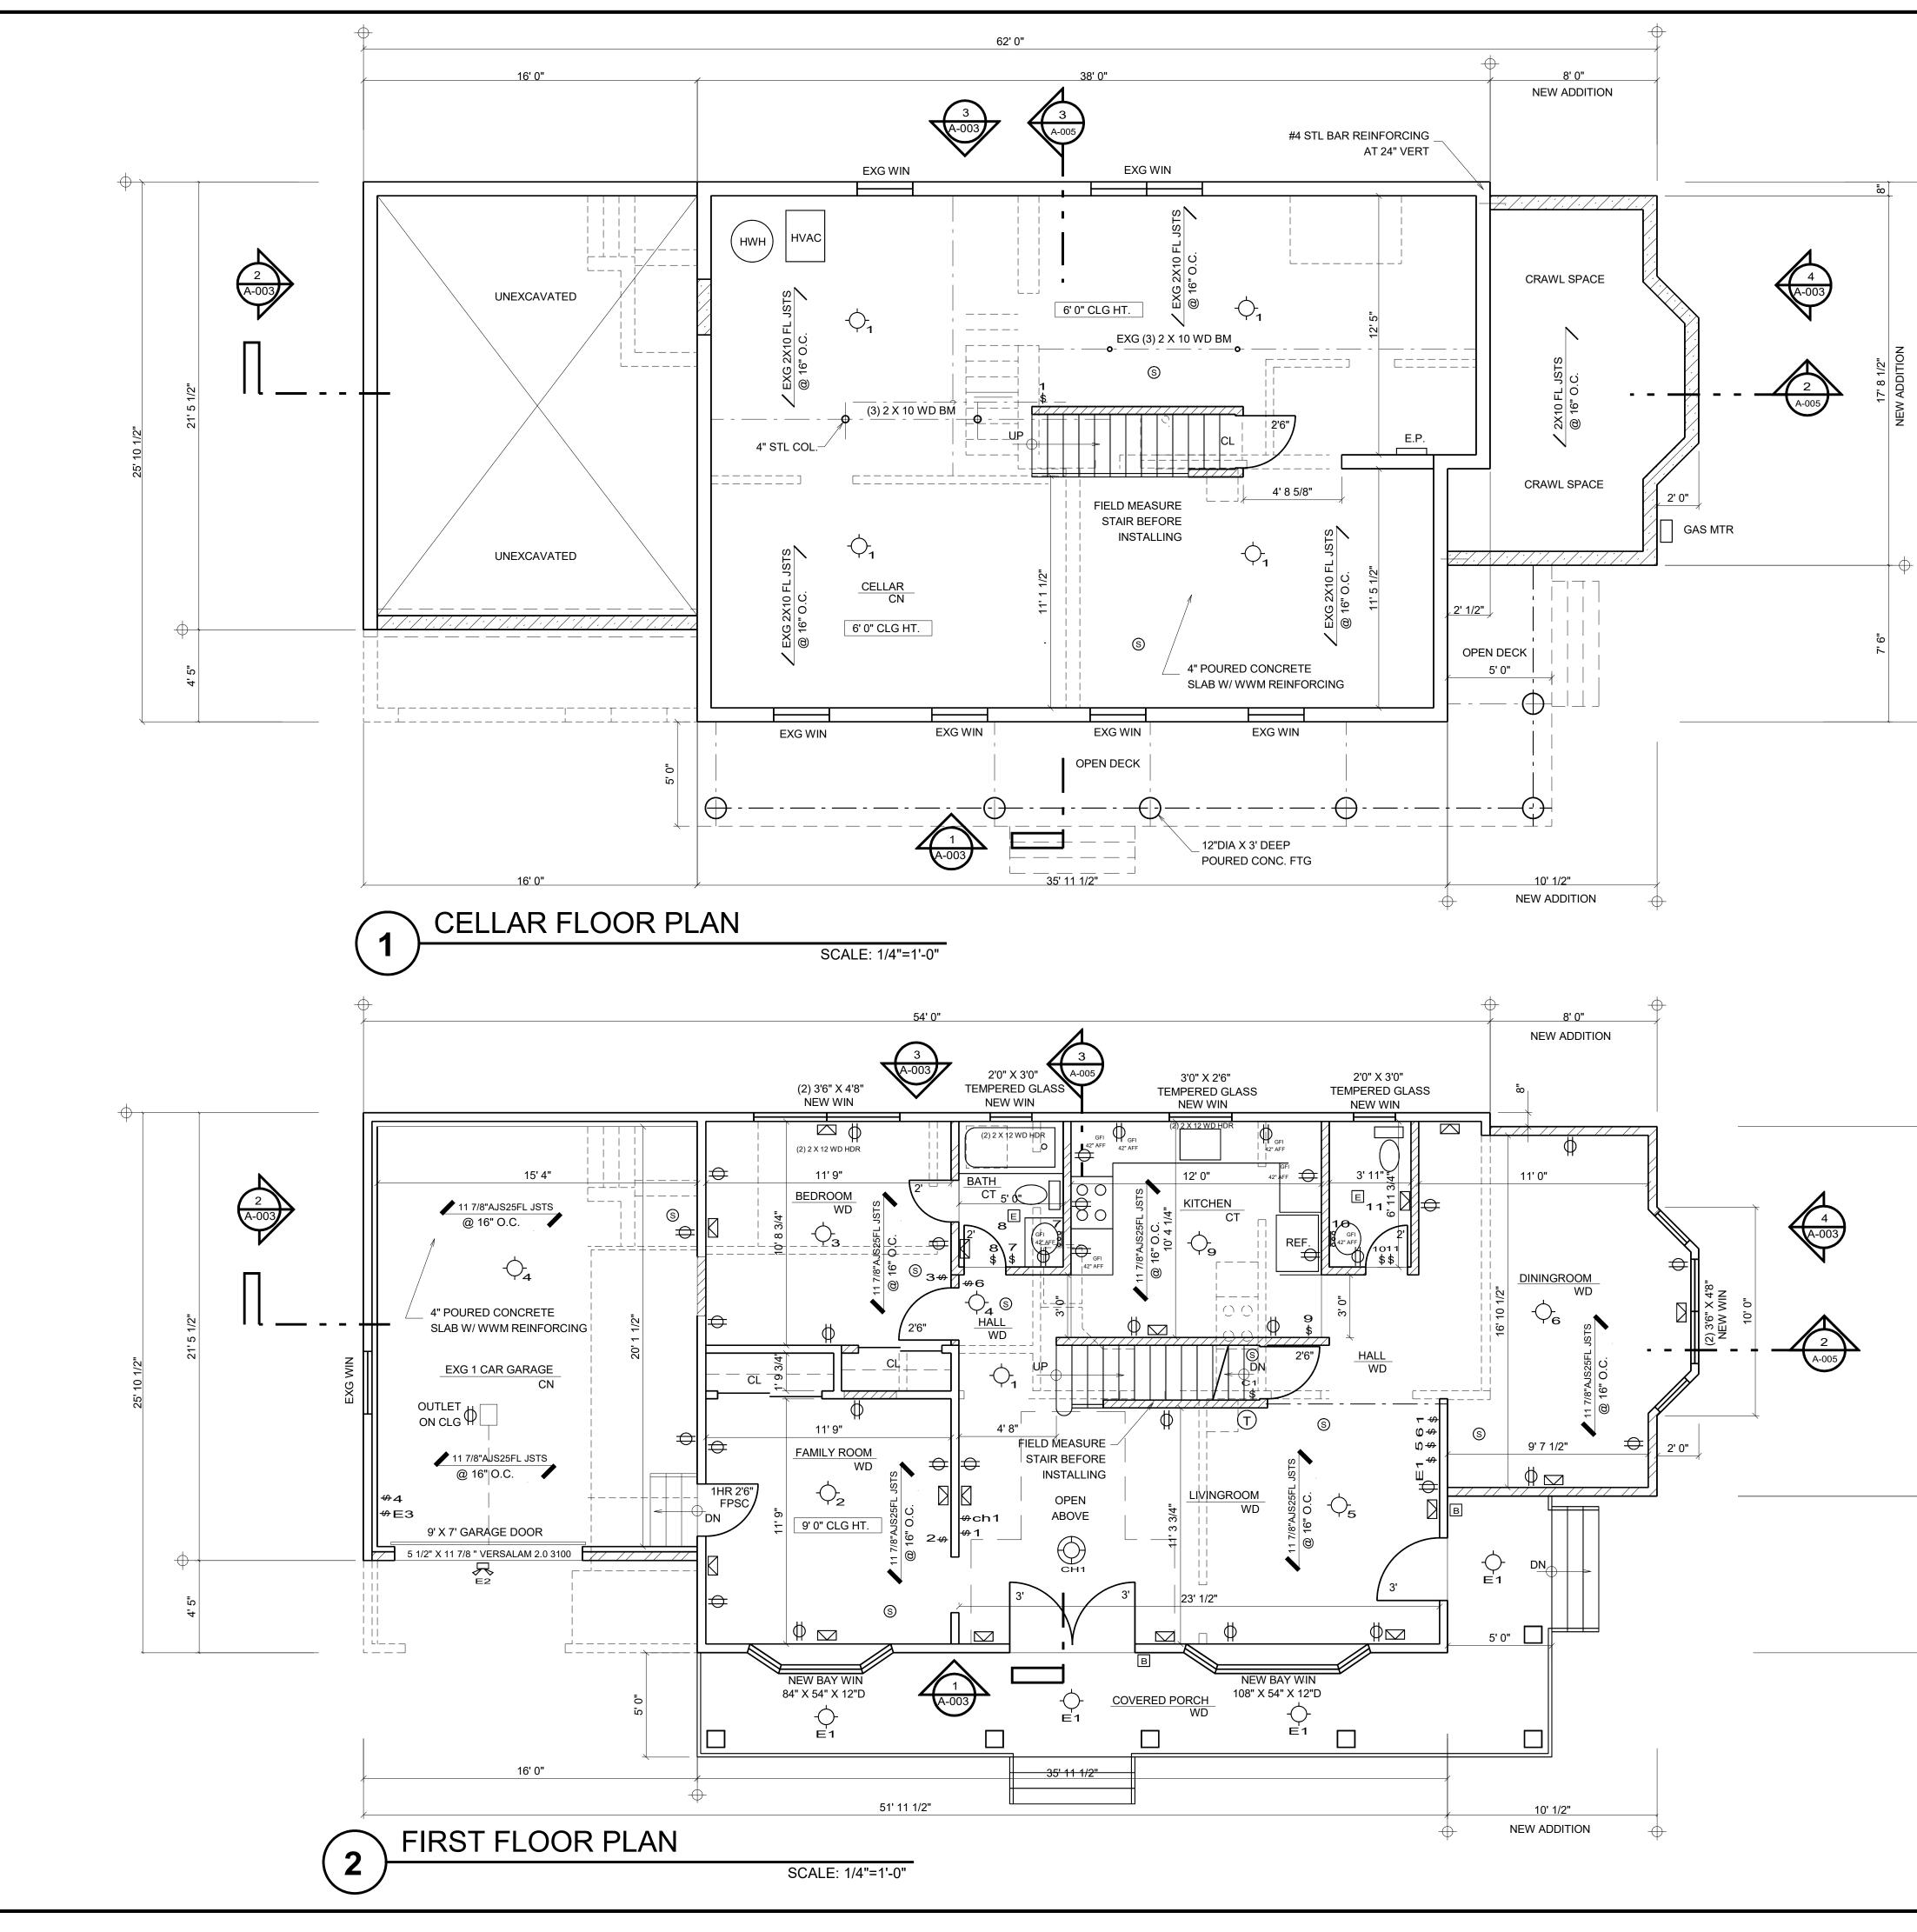

SYMBOL LEGEND		
-↓4 ○4 ●5 ●6 \$1	SURFACE MOUNTED LIGHT FIXTURE MAX 100W BULBS RECESSED MOUNTED LIGHT FIXTURE MAX 100W BULBS CEILING HUNG LIGHT FIXTURE MAX 100W BULBS SURFACE MOUNTED INCANDESCENT VANITY LIGHT FIXTURE (3) MAXIMUM 100W BULBS RECESSED EXHAUST FAN MINIMUM 80 CFM DUPLEX RECEPTICAL OUTLET, GFI IF INDICATED ELECTRICAL CONNECTION ELECTRICAL WALL SWITCH, NUMBER INDICATES DEVICE	
	SMOKE AND CARBON MONOXIDE DETECTOR HARD WIRED TELEPHONE JACK THERMOSTAT CONTROL DOOR BELL EXTERIOR FLOOD LIGHT FIXTURE (2) MAXIMUM 100W BULBS CEILING HUNG FAN LIGHT FLUSH MOUNTED RETURN AIR VENT AIR DIFFUSER	
	WALL LEGEND	
	 POURED CONCRETE WALL 2 X 4 WOOD STUD WALL @ 16" O.C. W/ 1/2" GYPSUM BD. ON EACH SIDE. 2X4 OR 2X6 WOOD STUD WALL @16" O.C W/ 1/2" GYP BD. ON INT. AND 1/2" CDX PLY ON EXT. WITH 1" RIGID INSULATION BOARD WITH DRYVIT FINISH SYSTEM AND 3 1/2" BATT MIN. INSULATION R=15 AND VAPOR BARRIER ON INT. SIDE 	
	 2 X 4 WOOD STUD WALL @ 16" O.C. W/ 5/8" FIRE RESISTIVE GYPSUM BD. TYPE "C" ON EACH SIDE AND 3 1/2" BATT INSULATION R=15 1 HR RATED WALL. GA WP3605, UL U305, ULC W301 2 X 4 WOOD STUD WALL @16" O.C. W/ 1/2" WATER RESISTIVE BD. ON WET SIDE AND 1/2" GYPSUM BD. ON DRY SIDE. EXISTING WALL 	
] WALL TO BE REMOVED	


JOHN RIG	PROJECT NO. 202133		
172 MAIN STREET METUCHEN, NJ 0	DRAWN BY J.R.		
TEL/FAX: (732) 902	2-2882		SCALE 1/4" = 1'-0"
SEAL	THE LAW PROHIBITS THE ALTERING OF THIS DOCUMENT. TO CHANGE THE DOCUMENT, THERE MUST BE A LICENSED ARCHITECT PRESENT AND ABLE TO SEAL IT.	REVISED	DATE 4-27-2022
	PROJECT	TITLE	DRAWING
	ADDITION AND ALTERATION TO ONE FAMILY HOUSE 326 DURHAM AVENUE	CELLAR AND FIRST FLOOR PLANS	A-001.00
	METUCHEN, NJ 08840		2 OF 6




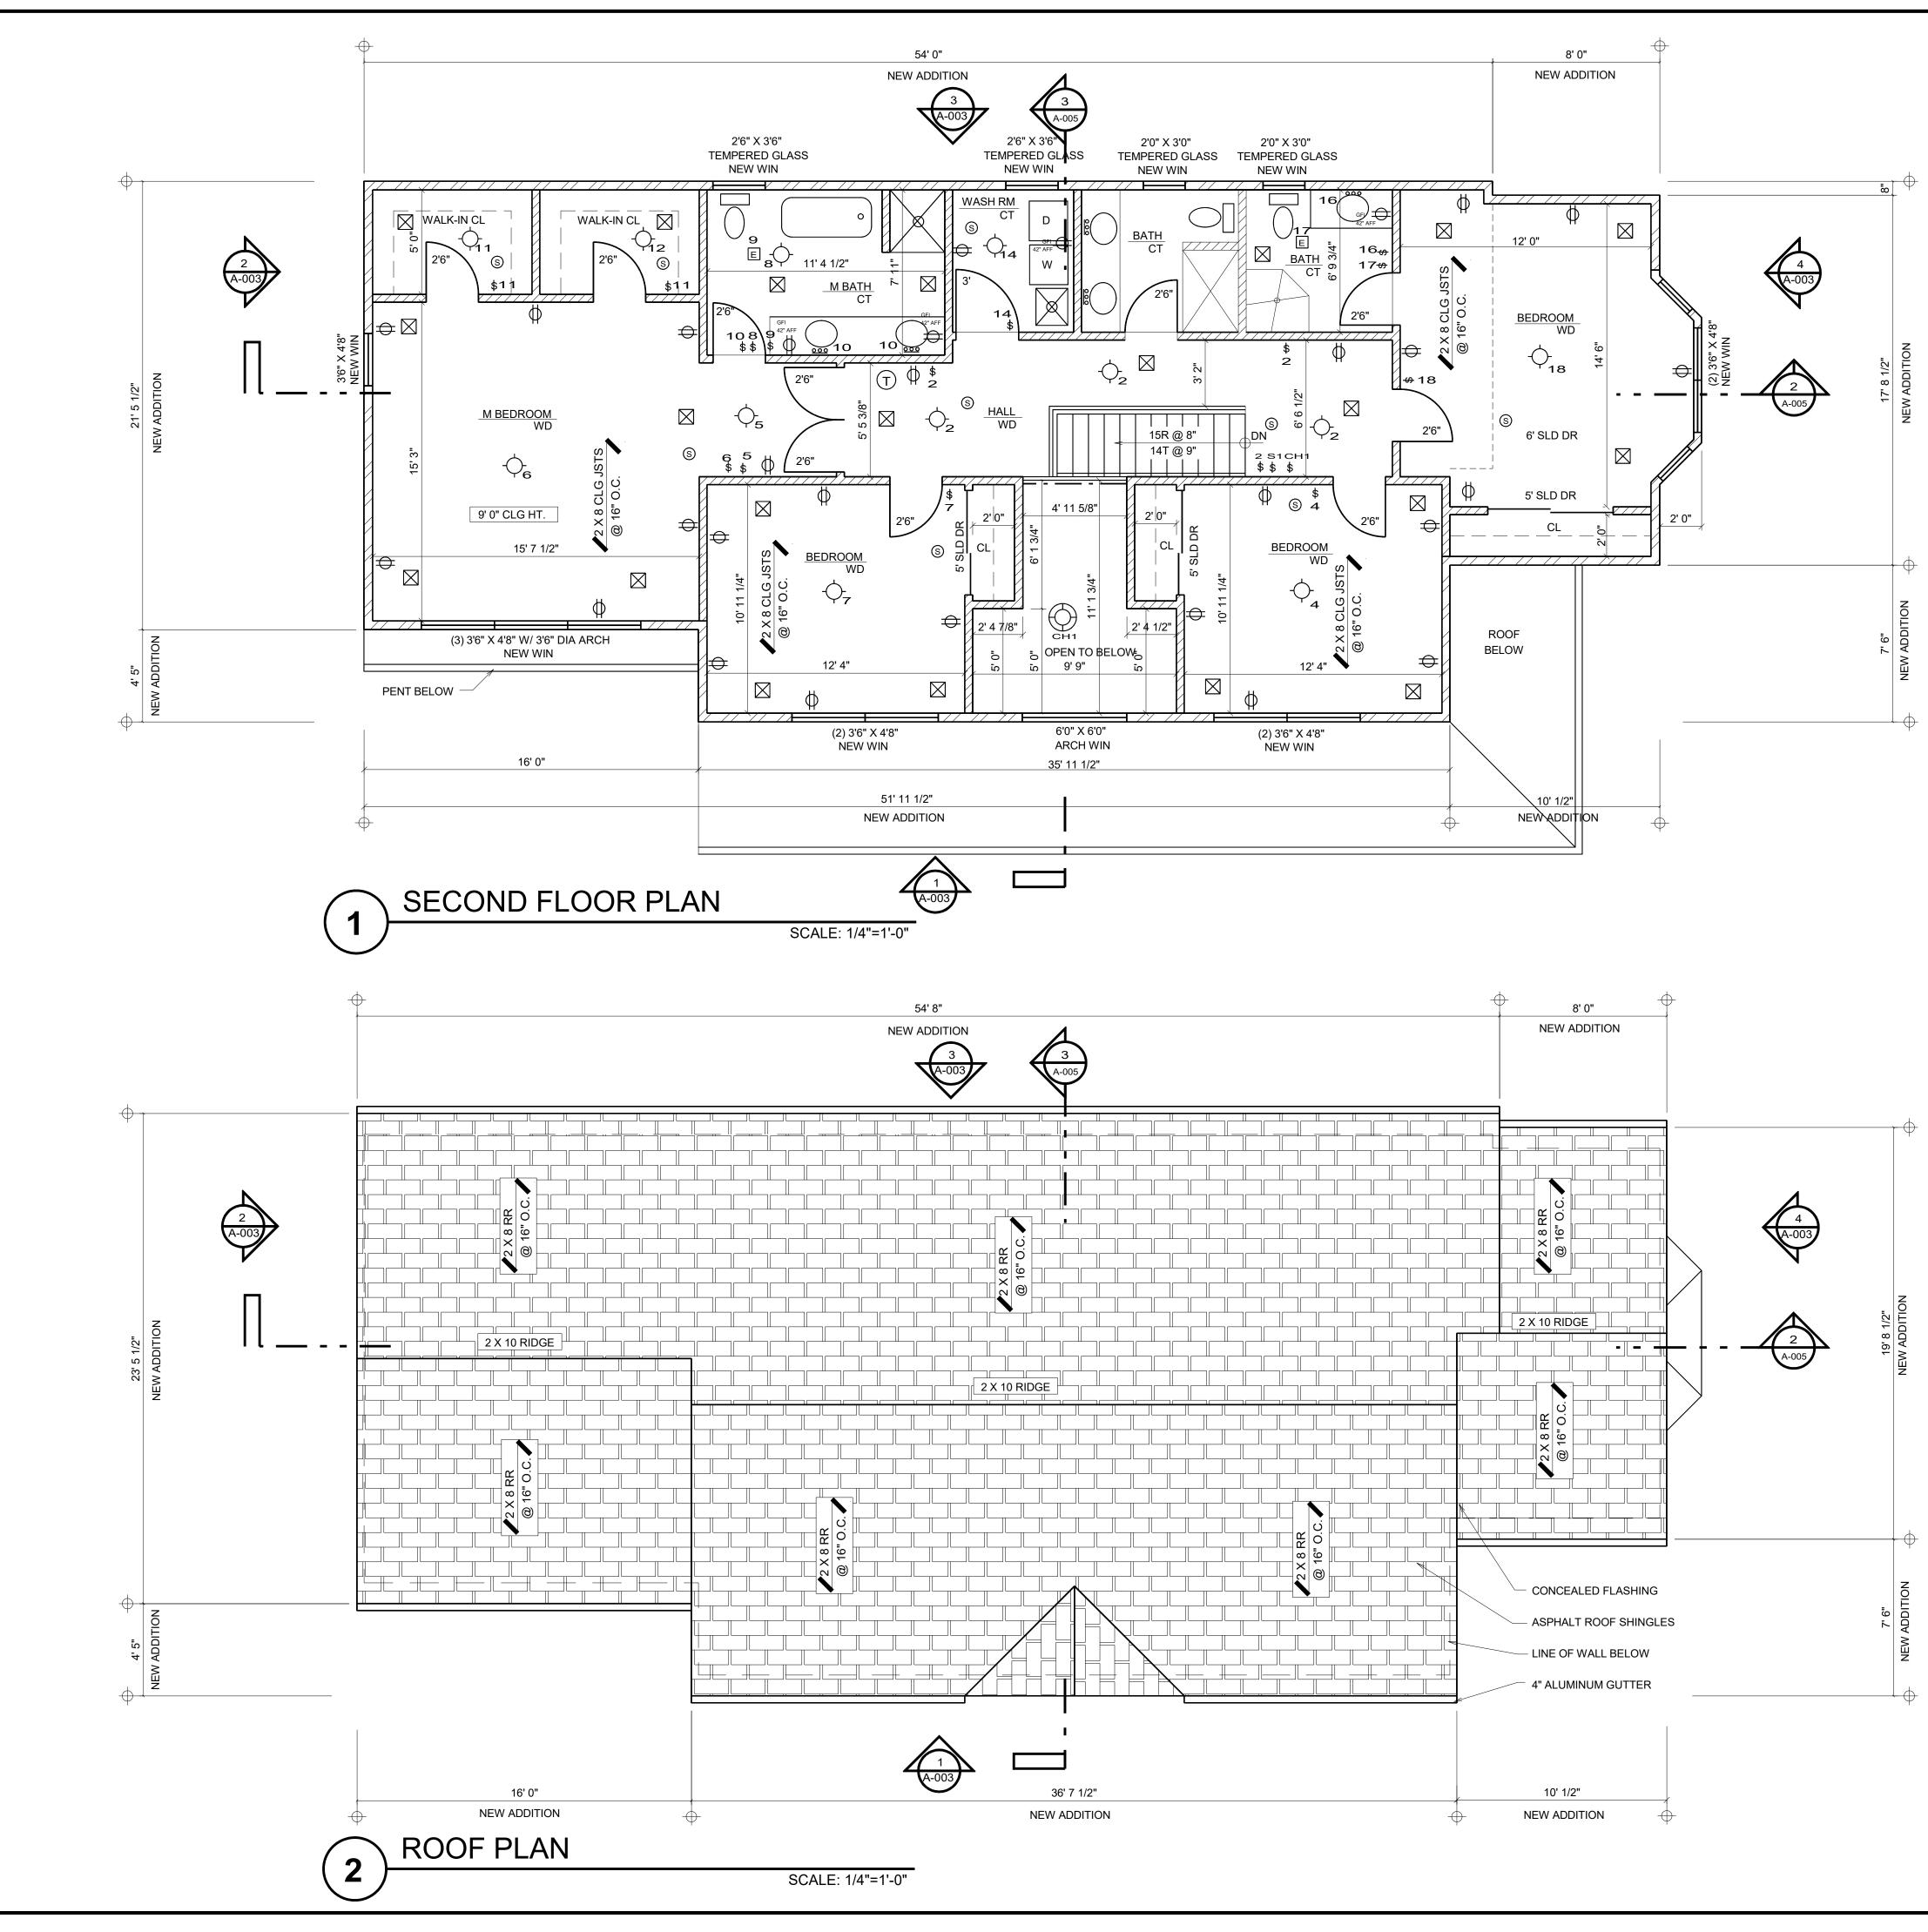

SYMBOL LEGEND		
ϕ_4	SURFACE MOUNTED LIGHT FIXTURE MAX 100W BULBS	
04	RECESSED MOUNTED LIGHT FIXTURE MAX 100W BULBS	
\bigcirc	CEILING HUNG LIGHT FIXTURE MAX 100W BULBS	
-) 4 	SURFACE MOUNTED INCANDESCENT VANITY LIGHT FIXTURE (3) MAXIMUM 100W BULBS RECESSED EXHAUST FAN MINIMUM 80 CFM	
ϕ_{gfi}	DUPLEX RECEPTICAL OUTLET, GFI IF INDICATED	
φ	ELECTRICAL CONNECTION	
\$1	ELECTRICAL WALL SWITCH, NUMBER INDICATES DEVICE	
© ▽ (T) B	SMOKE AND CARBON MONOXIDE DETECTOR HARD WIRED TELEPHONE JACK THERMOSTAT CONTROL DOOR BELL	
¥	EXTERIOR FLOOD LIGHT FIXTURE (2) MAXIMUM 100W BULBS	
×	CEILING HUNG FAN LIGHT	
	FLUSH MOUNTED RETURN AIR VENT	
\boxtimes	AIR DIFFUSER	
	WALL LEGEND	
	WALL LEGEND POURED CONCRETE WALL 2 X 4 WOOD STUD WALL @ 16" O.C. W/ 1/2" GYPSUM BD. ON EACH SIDE.	
	POURED CONCRETE WALL 2 X 4 WOOD STUD WALL @ 16" O.C. W/	
	 POURED CONCRETE WALL 2 X 4 WOOD STUD WALL @ 16" O.C. W/ 1/2" GYPSUM BD. ON EACH SIDE. 2X4 OR 2X6 WOOD STUD WALL @16" O.C W/ 1/2" GYP BD. ON INT. AND 1/2" CDX PLY ON EXT. WITH 1" RIGID INSULATION BOARD WITH DRYVIT FINISH SYSTEM AND 3 1/2" BATT MIN. INSULATION R=15 AND VAPOR BARRIER ON INT. SIDE 2 X 4 WOOD STUD WALL @ 16" O.C. W/ 5/8" FIRE RESISTIVE GYPSUM BD. TYPE "C" ON EACH SIDE AND 3 1/2" BATT INSULATION R=15 1 HR RATED WALL. GA WP3605, UL U305, ULC W301 	
	 POURED CONCRETE WALL 2 X 4 WOOD STUD WALL @ 16" O.C. W/ 1/2" GYPSUM BD. ON EACH SIDE. 2X4 OR 2X6 WOOD STUD WALL @16" O.C W/ 1/2" GYP BD. ON INT. AND 1/2" CDX PLY ON EXT. WITH 1" RIGID INSULATION BOARD WITH DRYVIT FINISH SYSTEM AND 3 1/2" BATT MIN. INSULATION R=15 AND VAPOR BARRIER ON INT. SIDE 2 X 4 WOOD STUD WALL @ 16" O.C. W/ 5/8" FIRE RESISTIVE GYPSUM BD. TYPE "C" ON EACH SIDE AND 3 1/2" BATT INSULATION R=15 	
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	 POURED CONCRETE WALL 2 X 4 WOOD STUD WALL @ 16" O.C. W/ 1/2" GYPSUM BD. ON EACH SIDE. 2X4 OR 2X6 WOOD STUD WALL @16" O.C W/ 1/2" GYP BD. ON INT. AND 1/2" CDX PLY ON EXT. WITH 1" RIGID INSULATION BOARD WITH DRYVIT FINISH SYSTEM AND 3 1/2" BATT MIN. INSULATION R=15 AND VAPOR BARRIER ON INT. SIDE 2 X 4 WOOD STUD WALL @ 16" O.C. W/ 5/8" FIRE RESISTIVE GYPSUM BD. TYPE "C" ON EACH SIDE AND 3 1/2" BATT INSULATION R=15 1 HR RATED WALL. GA WP3605, UL U305, ULC W301 2 X 4 WOOD STUD WALL @16" O.C. W/ 1/2" WATER RESISTIVE BD. ON WET SIDE AND 1/2" GYPSUM BD. ON DRY SIDE. 	


JOHN RIGGIO, RA ARCHITECT			PROJECT NO. 202133
172 MAIN STREET, SUITE 33 METUCHEN, NJ 08840			DRAWN BY J.R.
TEL/FAX: (732) 902-2882			SCALE 1/4" = 1'-0"
SEAL	THE LAW PROHIBITS THE ALTERING OF THIS DOCUMENT. TO CHANGE THE DOCUMENT, THERE MUST BE A LICENSED ARCHITECT PRESENT AND ABLE TO SEAL IT.	REVISED	DATE 4-27-2022
	PROJECT	TITLE	DRAWING
	ADDITION AND ALTERATION TO ONE FAMILY HOUSE 326 DURHAM AVENUE	FIRST AND SECOND FLOOR PLANS	A-002.00
	METUCHEN, NJ 08840		3 OF 6

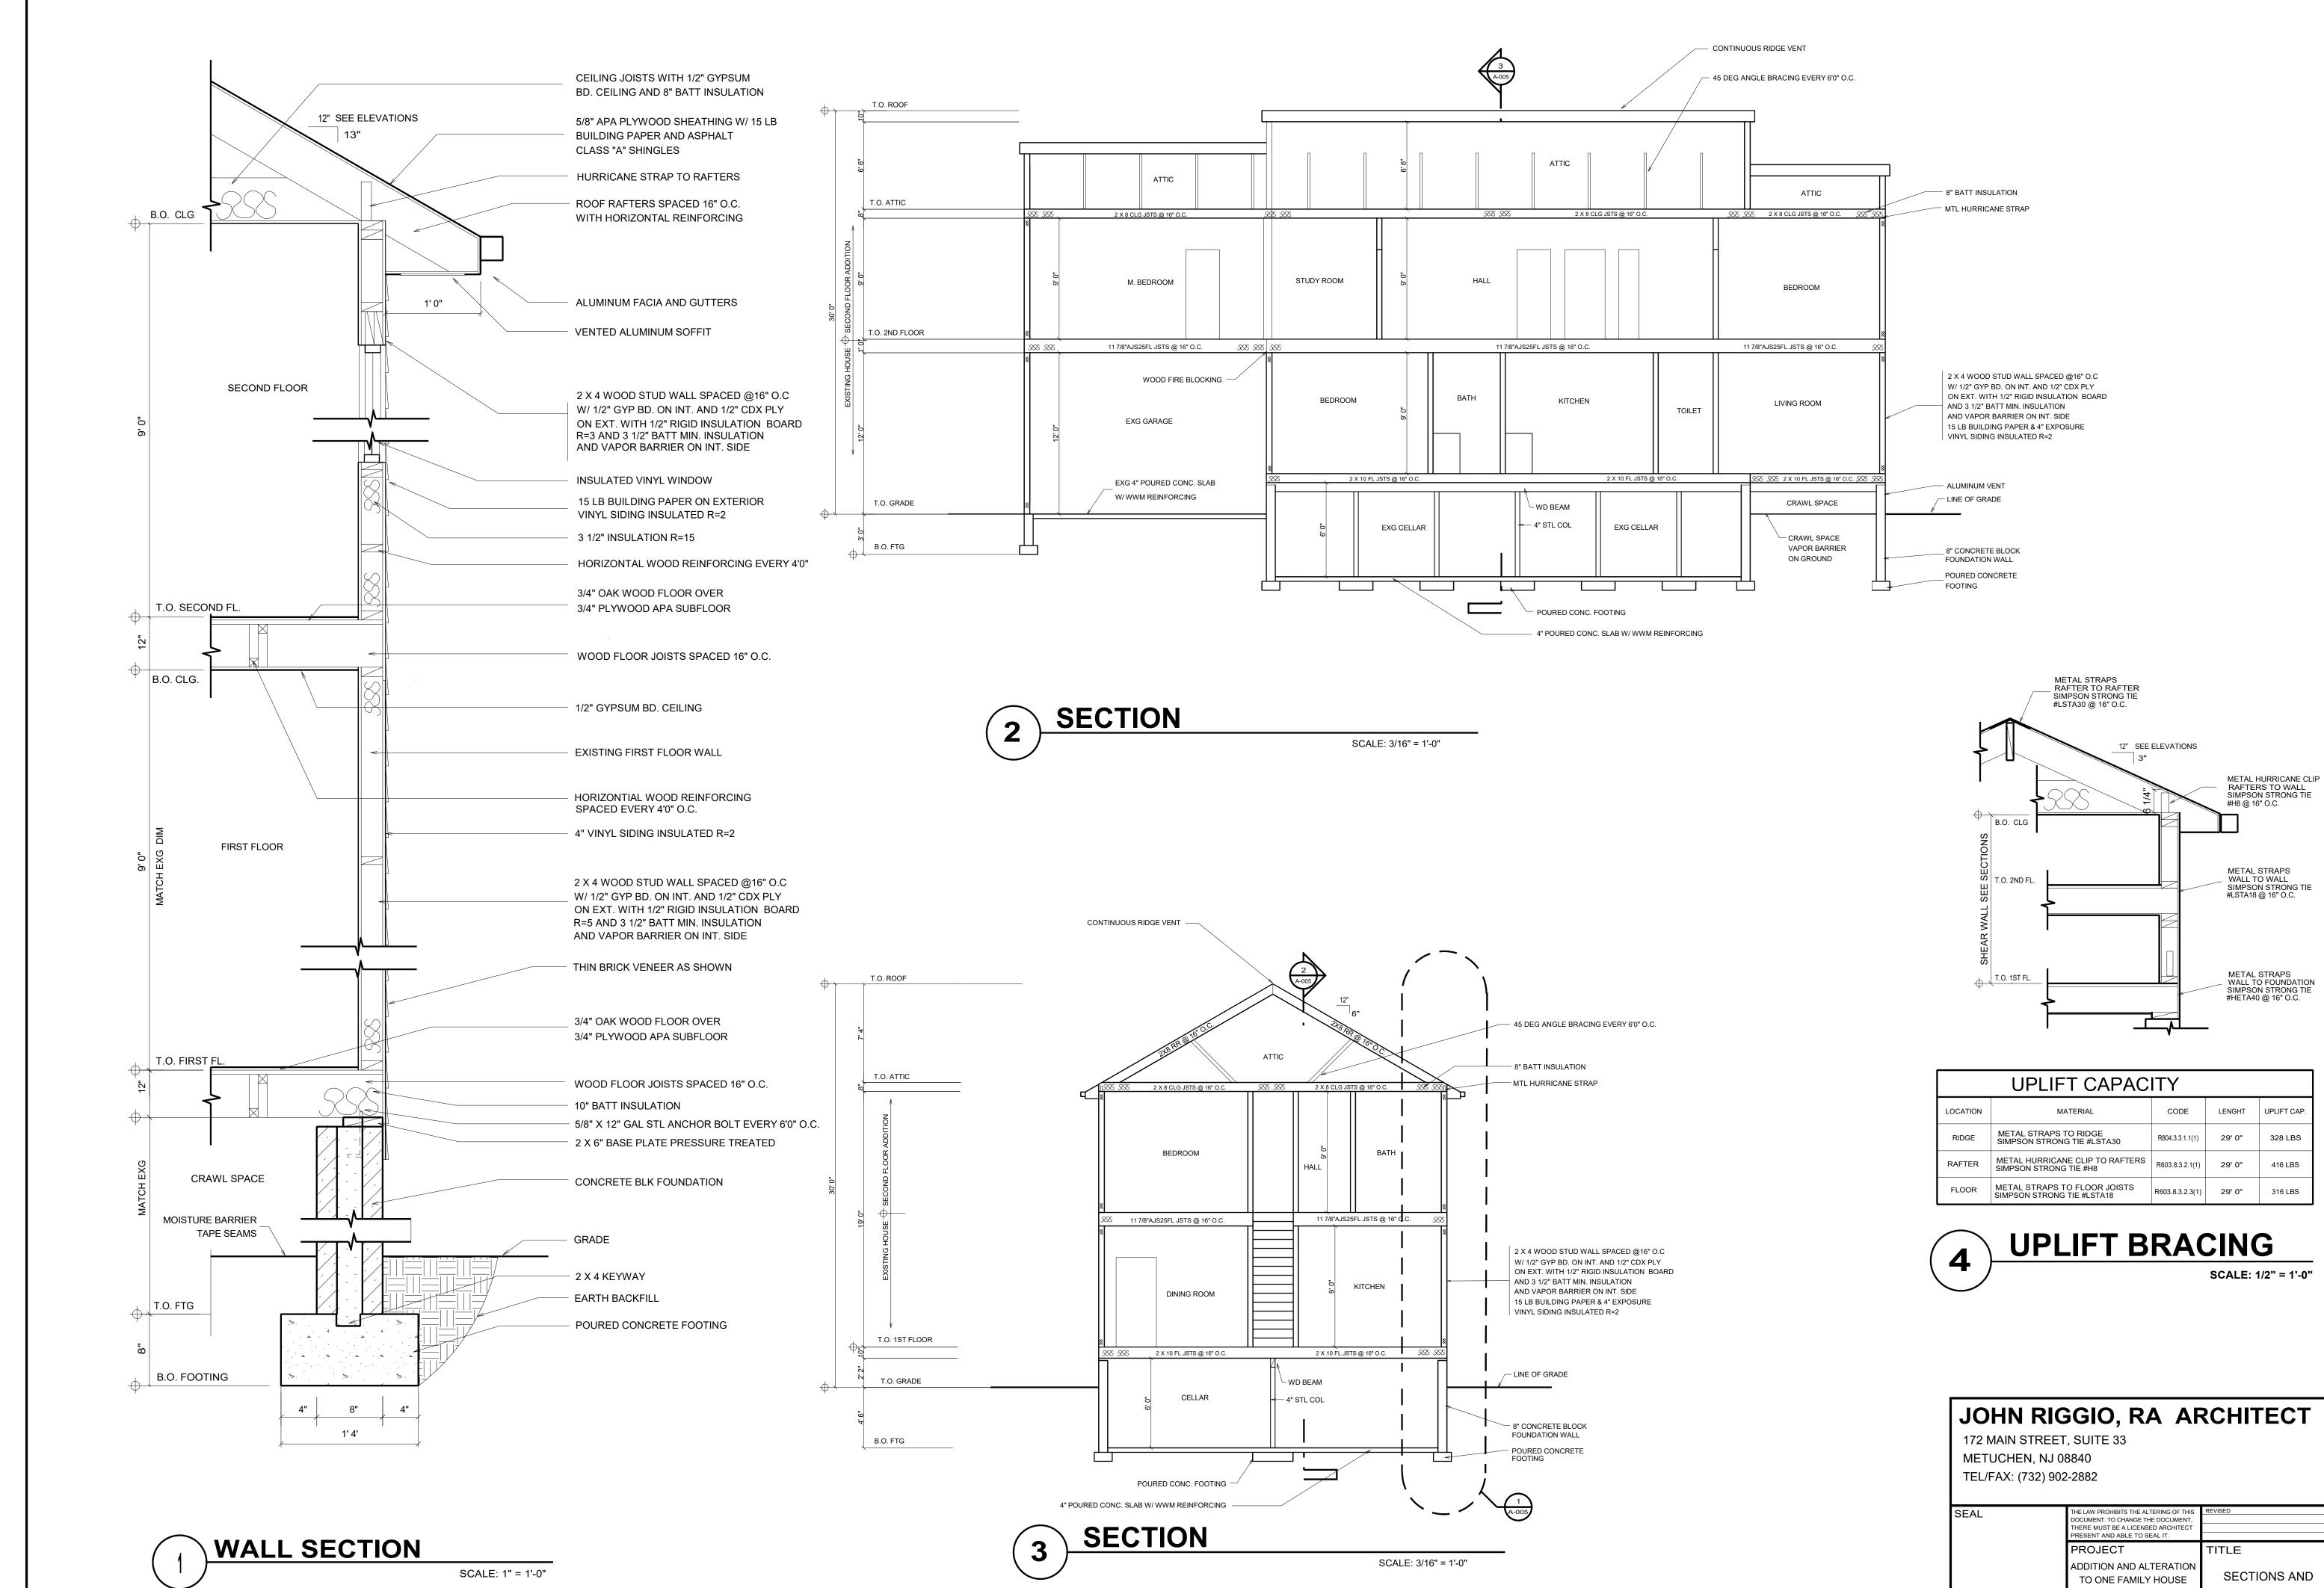


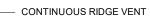



UPLIFT CAPACITY				
LOCATION	MATERIAL	CODE	LENGHT	UPLIFT CAP.
RIDGE	METAL STRAPS TO RIDGE SIMPSON STRONG TIE #LSTA30	R804.3.3.1.1(1)	29' 0"	328 LBS
RAFTER	METAL HURRICANE CLIP TO RAFTERS SIMPSON STRONG TIE #H8	R603.8.3.2.1(1)	29' 0"	416 LBS
FLOOR	METAL STRAPS TO FLOOR JOISTS SIMPSON STRONG TIE #LSTA18	R603.8.3.2.3(1)	29' 0"	316 LBS

JOHN RIG	PROJECT NO. 202133		
172 MAIN STREET METUCHEN, NJ 03	DRAWN BY J.R.		
TEL/FAX: (732) 902	SCALE 1/4" = 1'-0"		
SEAL	THE LAW PROHIBITS THE ALTERING OF THIS DOCUMENT. TO CHANGE THE DOCUMENT, THERE MUST BE A LICENSED ARCHITECT PRESENT AND ABLE TO SEAL IT.	REVISED	DATE 4-27-2022
	PROJECT	TITLE	DRAWING
	ADDITION AND ALTERATION TO ONE FAMILY HOUSE 326 DURHAM AVENUE	SECTIONS AND DETAILS	A-005.00
	METUCHEN, NJ 08840		6 OF 6

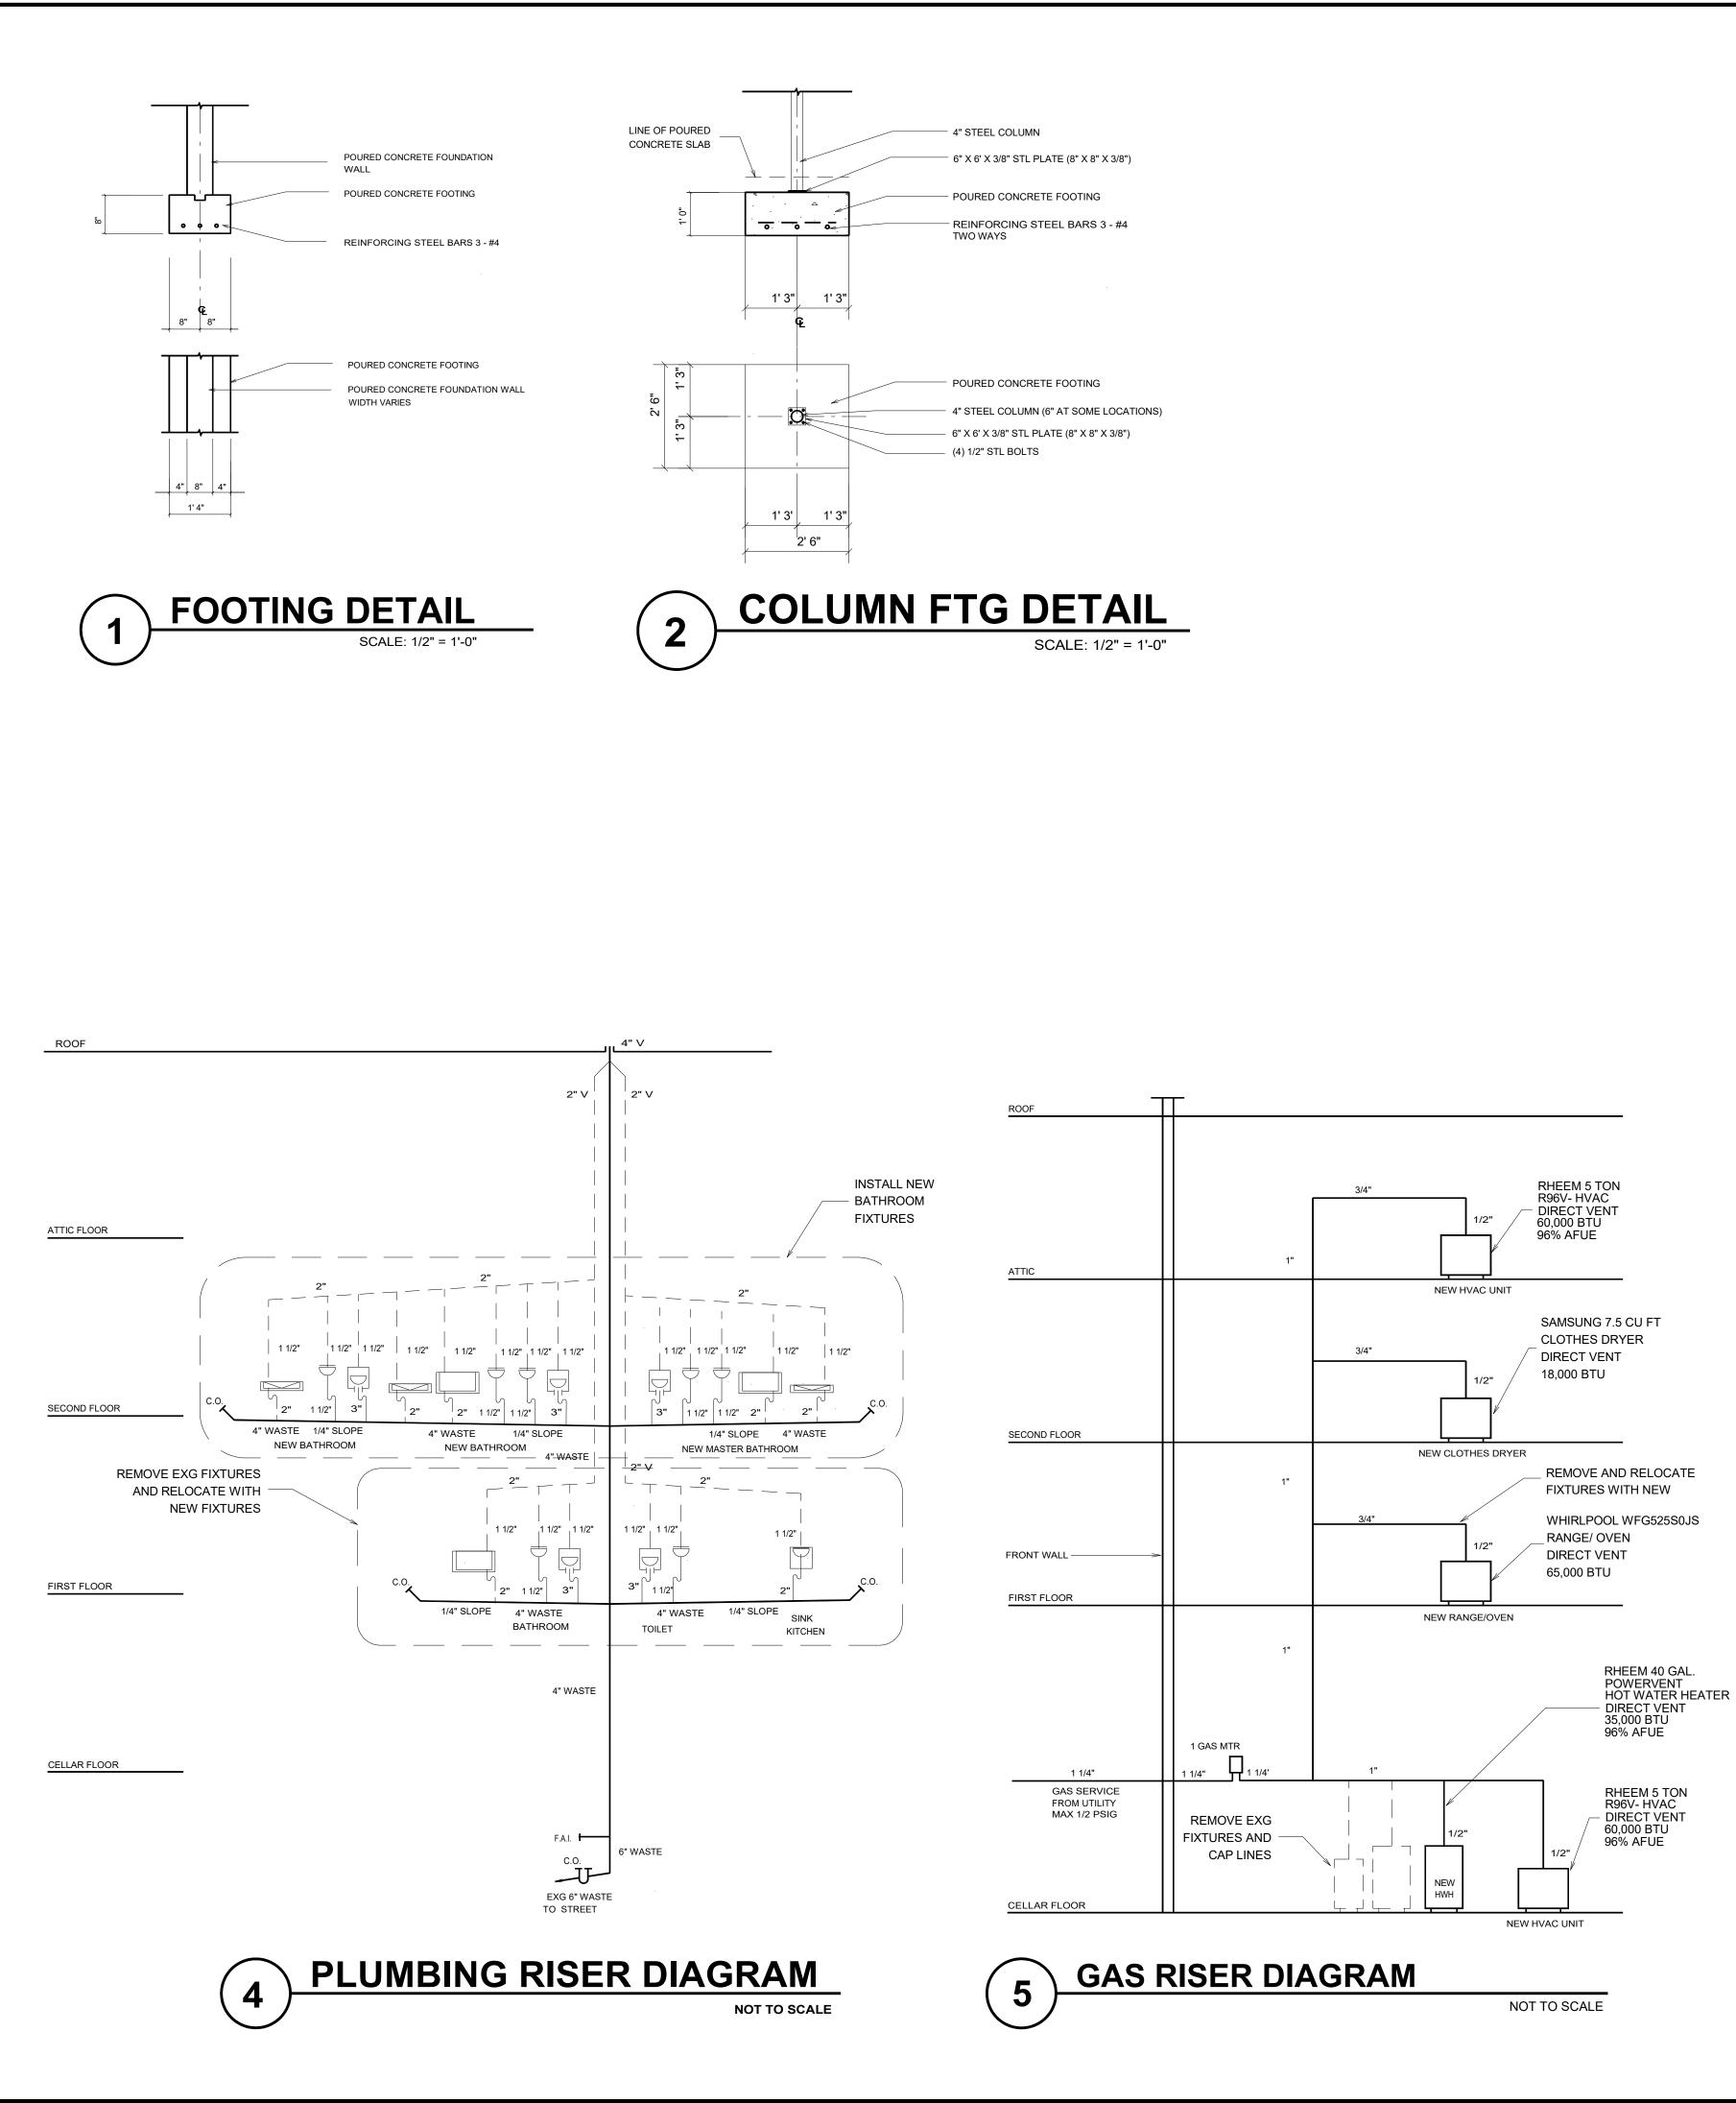

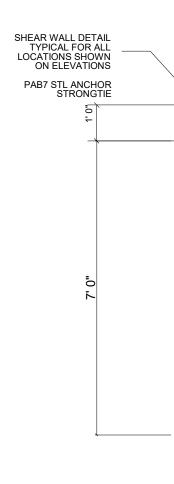


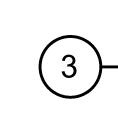

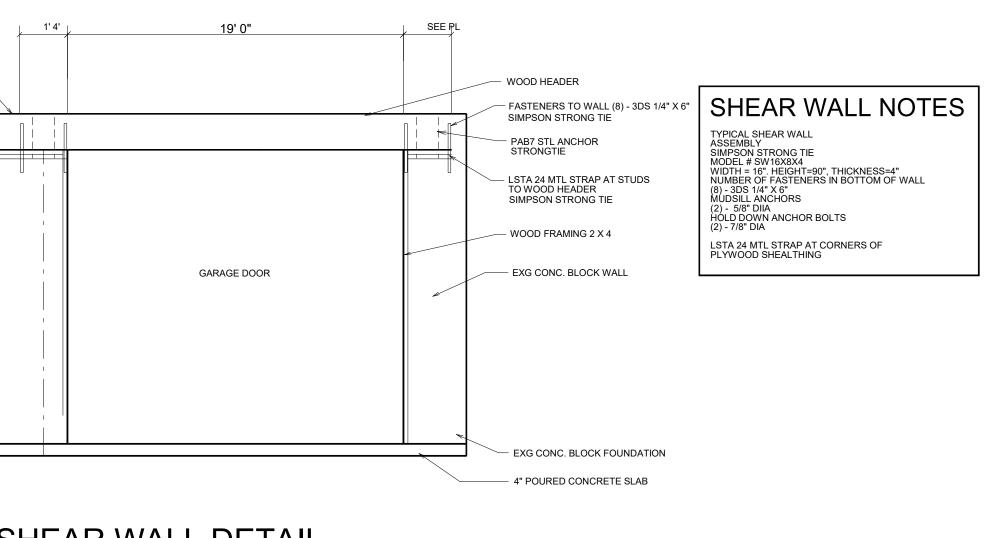

SHEAR WALL DETAIL SCALE: 3/8" = 1'-0"

> PROJECT NO. JOHN RIGGIO, RA ARCHITECT 202133 172 MAIN STREET, SUITE 33 DRAWN BY METUCHEN, NJ 08840 J.R. TEL/FAX: (732) 902-2882 SCALE 1/4" = 1'-0" DATE SEAL HE LAW PROHIBITS THE ALTERING OF TH DOCUMENT. TO CHANGE THE DOCUMENT, THERE MUST BE A LICENSED ARCHITECT PRESENT AND ABLE TO SEAL IT. 4-27-2022 DRAWING PROJECT TITLE ADDITION AND ALTERATION RISER DIAGRAMS A-004.00 TO ONE FAMILY HOUSE AND DETAILS 326 DURHAM AVENUE METUCHEN, NJ 08840 5 OF 6

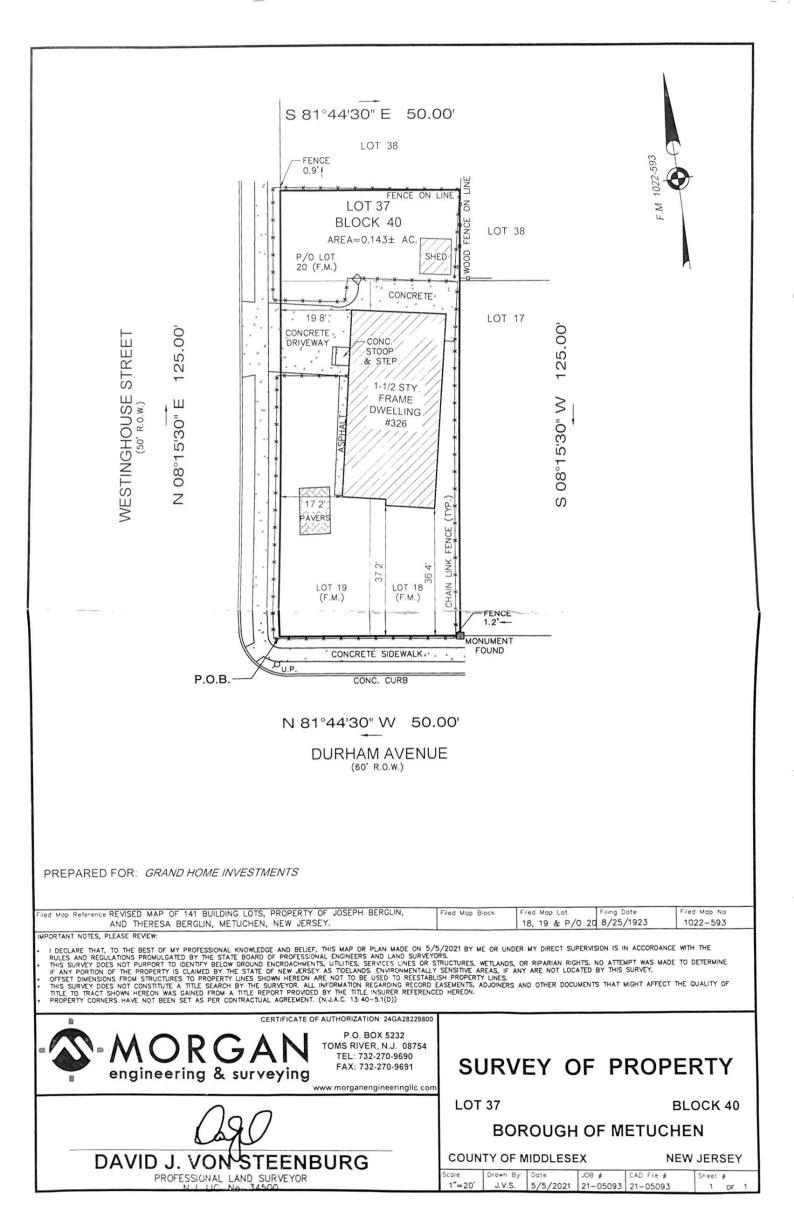

FREEHOLD SOIL CONSERVATION DISTRICT



(Serving Middlesex and Monmouth Counties)

4000 Kozloski Road, P.O. Box 5033 Freehold, New Jersey 07728-5033 Tel: (732) 683-8500 Fax: (732) 683-9140 E-mail: info@freeholdscd.org Website: www.freeholdsoil.org

12/9/2021

GRAND HOME INVESTMENTS LLC 5266 FOSTER STREET PISCATAWAY NJ 08854

Ref.#: 0012-C796 Proj.: 326 DURHAM AVENUE Twp. : METUCHEN Block: 40 Lots : 37

PROJECT EXEMPT ADDITIONS / IMPROVEMENTS TO EXISTING SINGLE FAMILY DWELLINGS

Dear GRAND HOME INVESTMENTS LLC,

This is to inform you that in accordance with the New Jersey Soil Erosion and Sediment Control Act; N.J.S.A. 4:24-39 et. seq., Chapter 251, P.L. 1975 and as amended by C. 264, P.L. 77 and C. 459, P.L. 79, a project is defined as "any disturbance of more than 5,000 square feet of the surface area of land for the accommodation of construction for which the State Uniform Construction Code would require a construction permit, except that the construction of a single-family dwelling unit shall not be deemed a 'project' under the act unless such unit is part of a proposed subdivision, site plan, conditional use, zoning variance, planned development or construction permit application involving two or more such single-family units,...".

In reference to the above site, improvements to a dwelling do not require certification of a Soil Erosion and Sediment Control plan. Should construction of a second dwelling or offsite soil disturbance greater than 5,000 square feet occur, certification of a Soil Erosion and Sediment Control plan would be required.

If you should have any questions, please-feel free-to-contact our office.

Sincerely,

ly Reynold, AF

cc: Planning Board Construction Official Municipal Engineer Applicant's Engineer



11 Electric Street Metuchen (377 Ft from Subject loction)




161 Durham Ave Metuchen (377 Ft from Subject loction)



12 Electric Street Metuchen (387 Ft from Subject location)



159 Durham ave Metuchen (0.4 Miles from Subject loction)

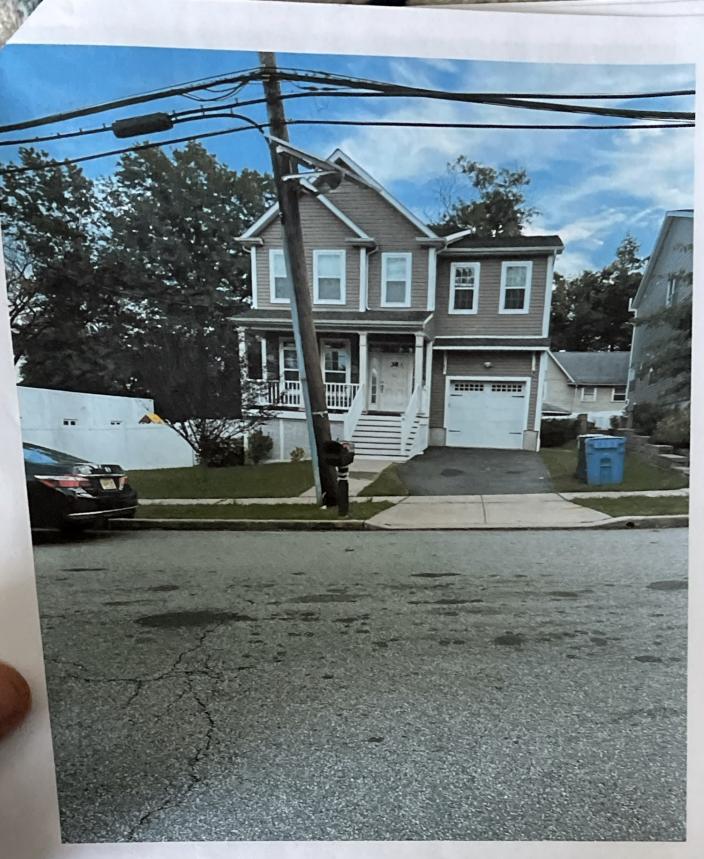

38 Hapton Street Metuchen (0.4 Miles from Subject loction)



682 New Durham Road Metuchen 0.6 Miles away from subject location bing maps

